
APPROVAL

TO: Frontier Communications
Att: Shellie Brown
Permit Coordinator
201 Flynn Road
Camarillo, CA 93012

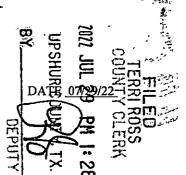

The Upshur County Commissioners Court offers no objections to the location on the right-of-way of your proposed:

Bore and install new drop boxes for fiber placing and splicing at 9989 FM2685 and Scarlett Oak Rd., N. Lake Dr.,

Pine Hills Rd, Hilton Springs Rd, White Fir Rd., S. Lake Dr., Lake Gladewater Rd, Hanna Dr., Spring Lake Dr. and

Baretta Rd. as shown by accompanying drawings and notice dated 07/20/22, except as noted below:

It is expressly understood that the Upshur County Commissioners Court does not purport, hereby, to grant and right, claim, title, or easement in or upon this county road; and it is further understood that in the future should for any reason Upshur County need to work, improve, relocate, widen, increase add to or any manner change the structure of this right-of-way line, this line, if affected, will be moved under the direction of the Upshur County Engineer and shall be relocated at the complete expense of the owner. Upshur County shall be notified a minimum of 48 hours prior to the beginning of any work.

All work on the county right-of-way shall be performed in accordance with the County Engineer's instructions. The installation shall not damage any part of the highway and adequate provisions must be made to cause minimum inconvenience to traffic and adjacent property owners. Special specifications for placing this line are as follows:

- 1. All ground lines are to be installed a minimum of 36 inches below the flowline of the adjacent drainage or borrow ditch.
- 2. All excavations within the right-of-way and not under surfacing shall be backfilled by tamping in 6 inch horizontal layers. All surplus material shall be removed from the right-of-way and the excavation finished flush with surrounding natural ground.
- 3. Lines crossing under surfaced roads and under surfaced cross roads within the right-of-way shall be placed by boring. Boring shall extend from crown line to crown line.
- 4. All lines under roads carrying pressure in excess of 50 psi shall be enclosed in satisfactory casing extending from right-of-way line to right-of-way line. Pipe used for casing may be of any type approved by the County Engineer and shall be capable of Supporting the load of roadbed and traffic and shall be so constructed that there will be no leakage of any matter through the casing for its entire length. Inside diameter of casing shall be at least 2 inches greater than the largest outside diameter of carrier pipe, joint or couplings. (Encasement is not required on lines installed 48 inches or greater below flowline.)
- 5. All lines, where practicable, shall be located to cross roadbed at approximately right angles thereto. No lines are to be installed under or within 50 feet of either end of a bridge unless approved by the County Engineer in writing. No lines shall be placed inside any culvert or within 10 feet of the closest point of same.
- 6. Parallel lines will be installed as near the right-of-way lines as is possible and no parallel line will be installed in the roadbed or between the drainage ditch and roadbed unless approved by the County Engineer in writing.
- 7. Overhead lines will have a minimum clearance of 18 feet above the road surface at point of crossing,
- 8. Operation's along roadways shall be performed in such a manner that all excavated material be kept off the pavements at all times, as well as all operating equipment and materials. Do not use equipment or installation procedures which will damage any road surface or structure. The cost of any repairs to road surfaces, roadbed, structures or other right-of-way features as direct result of this installation will be borne by the owner of this line.
- 9. Barricades, warning signs, lights and flagmen, when necessary, shall be provided by the contractor or owner. One half of the traveled portion of the road must be open to traffic at all times. All traffic control shall be in accordance with the requirements of the current version of the Texas MUTCD.
- 10. Utility company shall install adequate erosion control measures for any excavation work being performed.

APPROVED:	51-	APPROVED:	
	Road Administrator	Cl	hairnerson, Unshur County Commissioners Com

NOTICE OF PROPOSED INSTALLATION PIPE AND/OR UTILITY LINES

DATE: 7/20/22 TO: UPSHUR COUNTY COMMISSIONERS COURT EXPIRES: c/o UPSHUR COUNTY ENGINEER UPSHUR COUNTY ROAD & BRIDGE DEPARTMENT P.O. BOX 730 Gilmer, TX 75644 Formal notice is hereby given that _____proposes to bore a ____ line within the right-of-way of County Road as follows: Job Site Address: 9989 FM2685 and Scarlett Oak Rd; N Lake Dr; Pine Hills Rd; Hilton Springs Rd; White Fir Rd; S Lake Dr; Lake Gladewater Rd Hanna Drive; Spring Lake Drive; Baretta Rd Frontier Communications proposes to bore 25,851' of (1)-1.25" duct 186' of (2)-1.25" ducts, install (66) New 17"x30" HHs (22) New 2'x3' HHs and (24) New 11"x11"x16" Drop Boxes for fiber placing and splicing. **5291449** The location and description of the proposed line and appurtenances is more fully shown by three copies of drawings attached to this notice. The line will be constructed and maintained on the County right-of-way as directed by the County Engineer in accordance with current Upshur County specifications. Construction of this line will begin on or after the 15th day of August , 20 22 and will be completed within 90 days of the date of approval. Frontier Communications Firm Shellie Brown By Title Permit Coordinator Address 201 Flynn Road, Camarillo CA 93012 NOTE: 1. This form to be submitted in triplicate for each proposed installation.

. 2. The permit shall be in effect until the utility line is removed from the right of way.

3. Inform the County Engineer if work is not completed within this time.

FRONTIER COMMUNICATION CONSTRUCTION SPECIFICATIONS

- 1. Contact Frontier Engineer CORY RIGGS at (310) 210-9882 show (80) days order to need of service in order to confirm compliance, order materials, and schedule work forces. NOTE: FRONTIER COMMUNICATIONS INCORPORATED, RESERVES THE RIGHT TO REFUSE ANY CONDUIT, PULL BOXES, MANHOLES, OR UTILITY BOXES THAT DEVIATE FROM PLANS AND SPECIFICATIONS.
- 2. All conduit riser bends to have a minimum thirty-six (35) inch radius.
- All horizontal ninety (90) degree bends shall have a minimum radius of 12.5 feet and all vertical ninety (90) degree bends shall have a minimum radius of three feet. No more than two ninety (90) degree horizontal bends shall be placed in any single run unless otherwise specified. Contact the Frontier engineer concerning any required deviations,
- All conduit must be proven using a mandrel no less than a 1/2" smaller than the conduit placed. Wall to wall measurements must be taken with a measured tape and a 3/8" polypropylene pull rope in each duct. An accurate wall to wall measurement of conduit placed must be As-built on an approved Frontier construction plan. A copy of the As-built conduit work order must be provided to the Frontier inspector assigned to your project.
- 5. Place weatherproof caps on all terminated conduits.
- Approved plastic conduit (PVC Sch. 40,TYPE-C or HDPE (2") is to be used in underground construction unless otherwise specified.
- 7. Conduit terminated on a pole must be PVC Sch. 80. Location of riser on pole will be called out by engineering on the construction plan.
- 8. Conduit placed in same trench with primary power conduit must be separated by a minimum of twelve (12) inches of well-packed sand or three inches of concrete, and have a minimum of sbdy (80) inches of cover when placed behind curb face. All street crossings and conduits placed in the driven portion of the roadway must have a minimum of sixty (60) Inches of cover to top of pipe. CONTACT THE FRONTIER INSPECTOR 48 HOURS BEFORE TRENCHING AND UPON COMPLETION OF YOUR SUBSTRUCTURES TO SCHEDULE THE FINAL INSPECTION.

PERMITTING AGENCY: **UPSHUR COUNTY**

PICK UP POINT:


PATH FOOTAGE:

MATERIALS: (68) NEW 17"X30" HH (22) NEW 2'X3' HH (24) NEW 11"X11"X18" DROP BOX 25651' OF (1)-1,25" DUCT 366' OF (2)-1.25" DUCTS



CONSTRUCTION PACKAGE

FDH- 9989 FM 2685 SCARLET OAK DR & FM 2685 GILMER, TX 75644

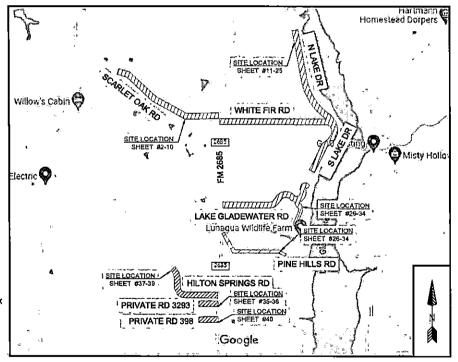

VICINITY MAP

HDPE AND PVC FOOTAGES DO NOT INCLUDE SWEEPS -ACTUAL FOOTAGES OF HOPE AND PVC WILL BE NEEDED TO ORDER MATERIALS, PLEASE INCLUDE MEASURED TAPE IN ALL PVCS. -FRONTIER INSPECTOR SHALL BE PRESENT ON SITE WHEN CONTRACTOR NEEDS TO ACCESS ANY EXISTING FRONTIER FACILITY.

ABBREVIATIONS

BLDG	BUILDING	PED	PEDESTAL (UTILITY)		
C/L	CENTER LINE	PVC	POLYVINYL CHLORIDE		
CONC	CONCRETE	P/L	PROPERTY LINE		
CSW	CONCRETE SIDEWALK	RR	RAILROAD		
DWY	EX. DRIVEWAY	R/W	RIGHT OF WAY		
EOC	EDGE OF CURB	SL	STREET LIGHT		
EOP	EDGE OF PAVEMENT	W-BLDG	WALL TO BUILDING		
ETW	ETWLINE	W-P	WALL TO POLE		
HH	HANDHOLE	W-W	WALL TO WALL		
MH	MANHOLE	P.U.E.	PUBLIC UTILITY EASEMENT		
NTS	NOT TO SCALE	C/G	CURB AND GUTTER		


	LEGEND
<u> </u>	New Trench
<u> </u>	New Bore
	Existing Gas
	Existing Water
	Existing Telephone
-	Existing Sewer
	Existing Storm Orain
	Existing Electric
	Existing Manhole
-	Existing Handhote (2"x3" or 17"x30")
	DSLAM
⊠ E	X-CONNECT
	POWER PEDESTAL
23	TELCO PEDESTAL
	3, X 2, LATT BOX
8	POLE


COMMUNICATIONS

JOB ID: 5291449 DATE: 07/19/2022 TITLE: FDH- 9989 FM 2685 STREET ADDRESS: 9989 FM 2685

CITY/STATE: GILMER , TX 75644 (UPSHUR COUNTY) FTR ENGINEER: CORY RIGGS (310) 210-9882

SHEET# 1 OF 48

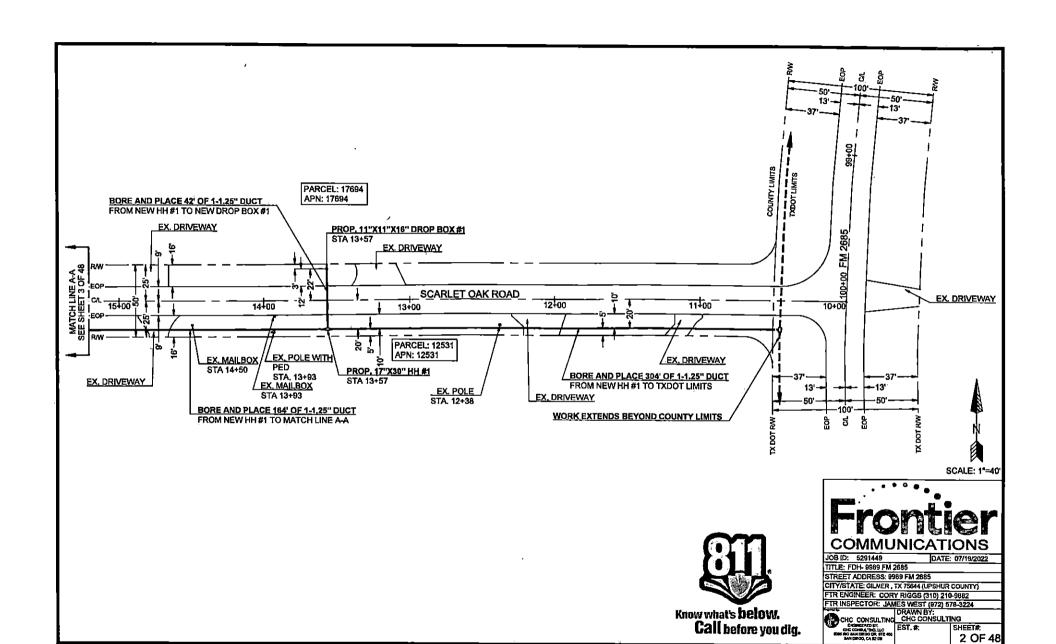

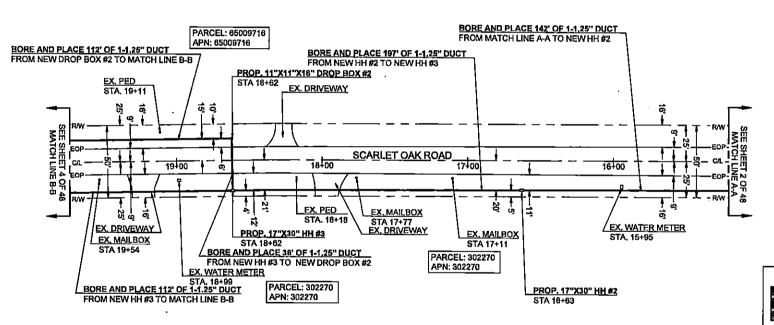








JOB ID: 5281449 DATE: 07/19/2022

TITLE: FDH- 9989 FM 2685


STREET ADDRESS: 9989 FM 2685

STREET ADDRESS: 9899 FM 2585
CITY/STATE GLIMER, TX 75684 (UPSHUR COUNTY)
FTR ENGINEER: CORY RIGGS (310) 210-9882
FTR INSPECTOR: JAMES WEST (972) 578-3224

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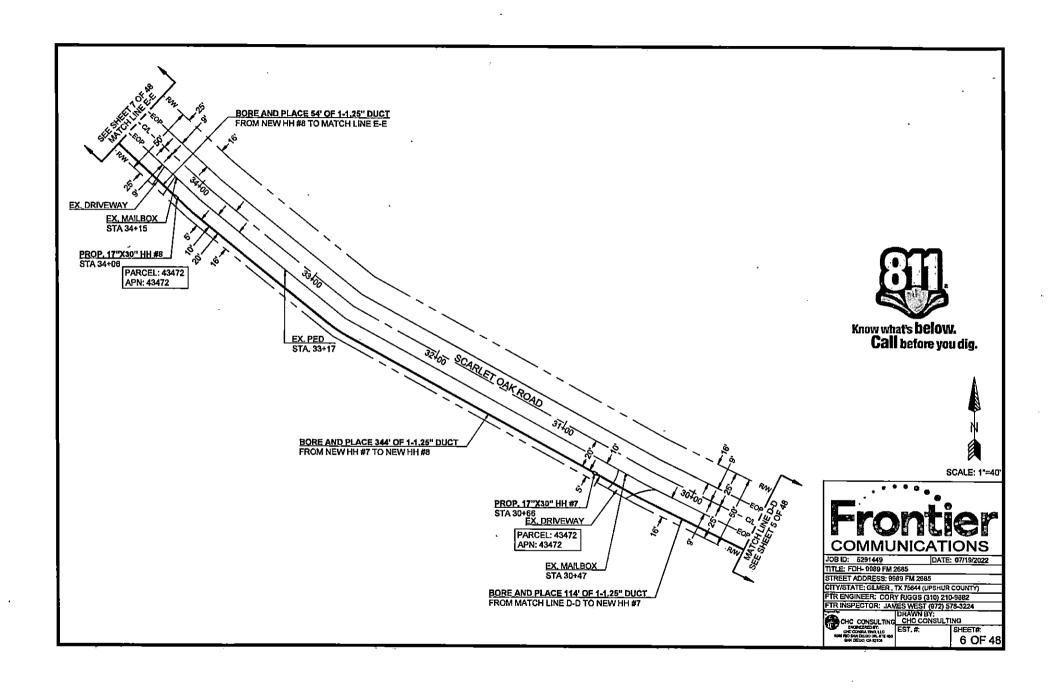


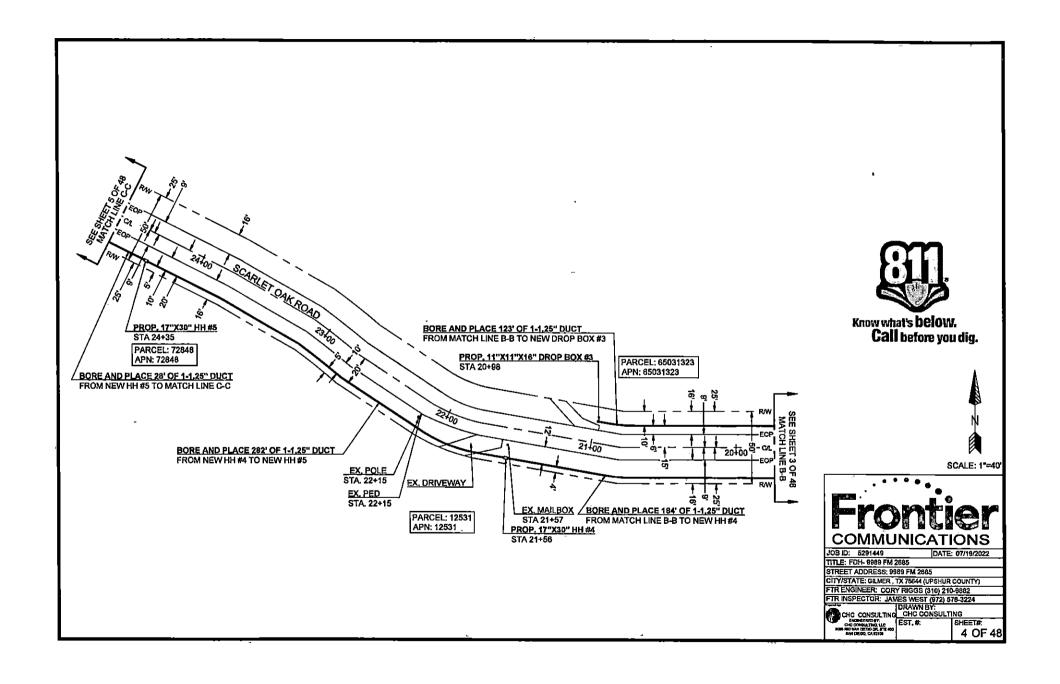


JOB ID: 5291449

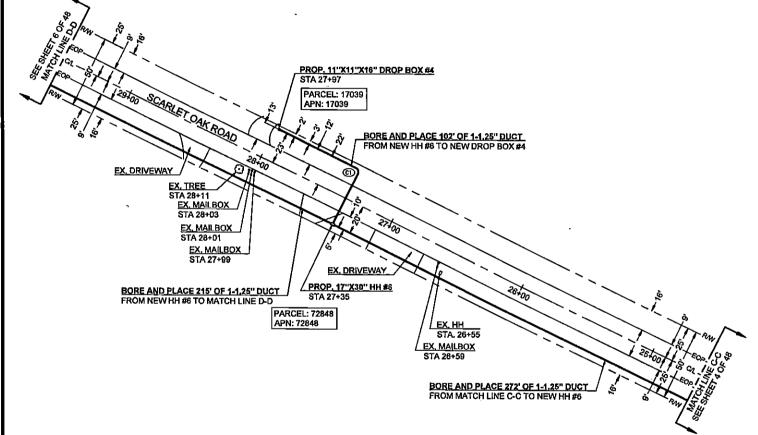TITLE: FDH- 9989 FM 2685

STREET ADDRESS: 9989 FM 2685
CITY/STATE: GLIVER, TX 75644 (UPSHUR COUNTY)
FIR ENGINEER: CORY RIGGS (310) 210-9802
FR INSPECTOR: JAMES WEST (972) 578-3224
DRAWN BY:
CHC CONSULTING
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SHEET#:
SHEET



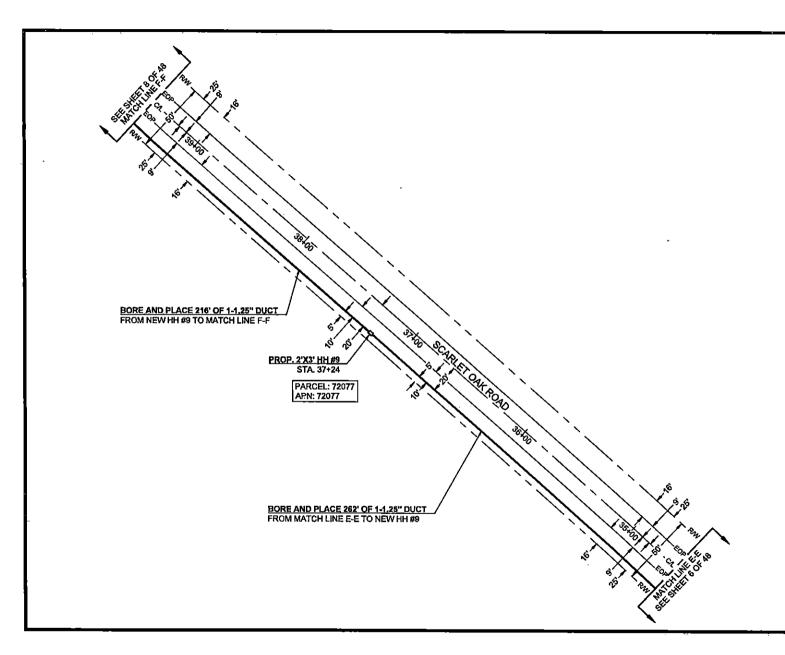









JOB ID: 5291449 TITLE: FDH- 9989 FM 2685

STREET ADDRESS: 9889 FM 2885
CITY/STATE: GLMER, TX 75844 (UPSHUR COUNTY)
FTR ENGINEER: CORY RIGGS (319) 210-9882
FTR INSPECTOR: JAMES WEST (972) 578-3224
DRAWN BY:
CHC CONSULTING
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SHEET# 7 OF 48



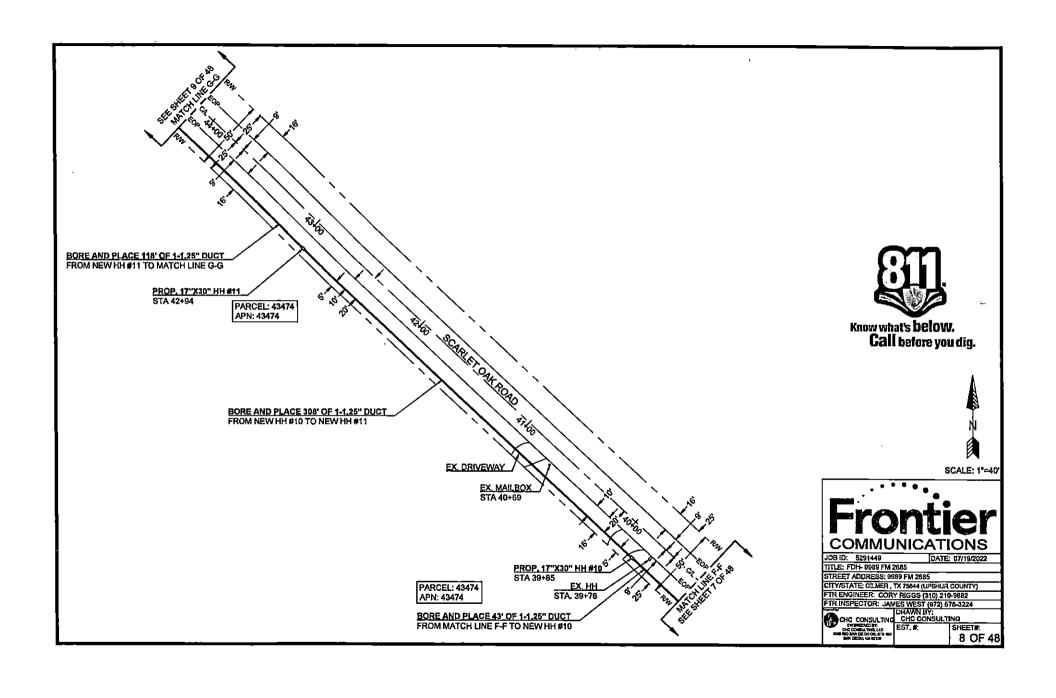

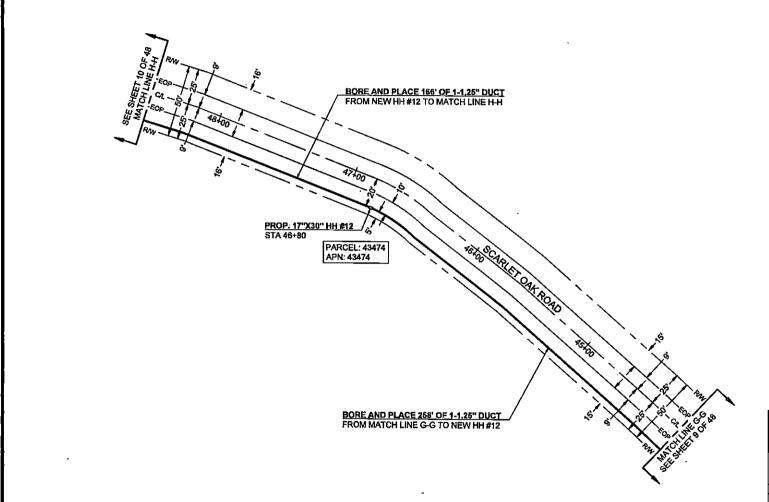






JOB ID: 5291449 TITLE: FDH- 9989 FM 2685

CURVE	RADIUS	LENGTH	DELTA
C1	3*	5'	90.

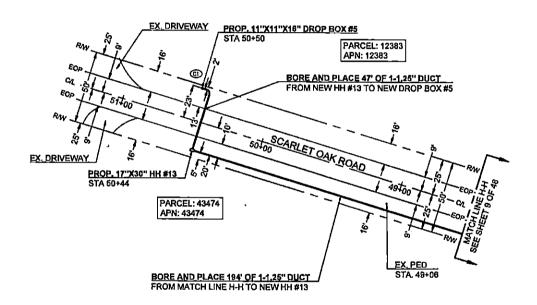











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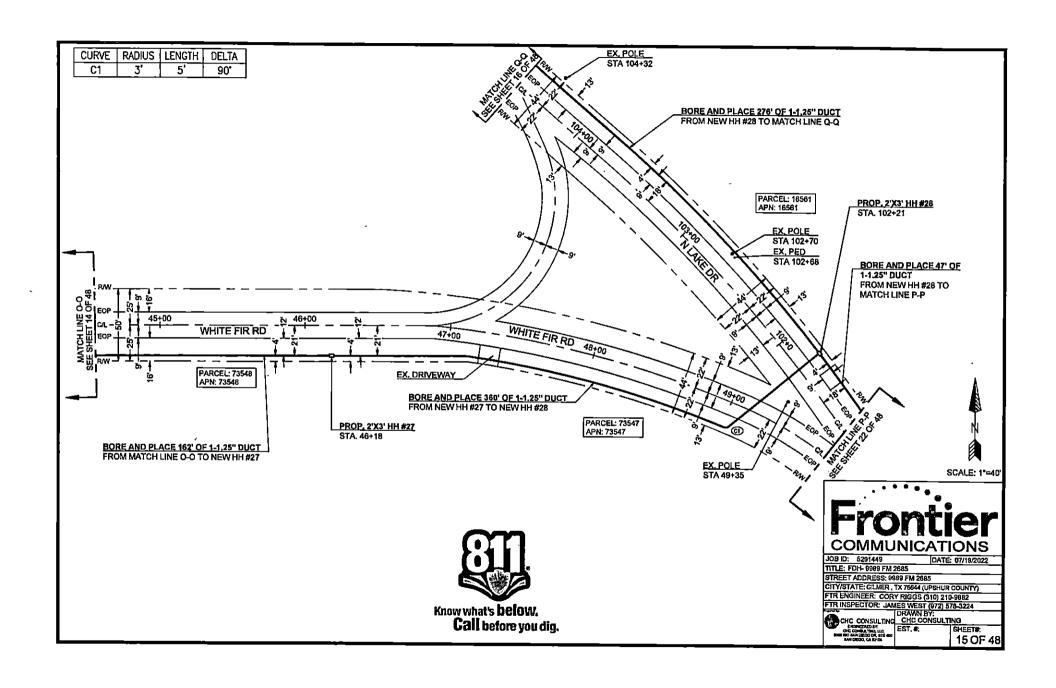
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CITY/STATE: GLMER, TX 76644 (UPSHUR COUNTY)
FTR ENGINEER: CORY RIGGS (310) 210-9882
FTR INSPECTOR: JAMES WEST (972) 578-3224
DRAWN BY:
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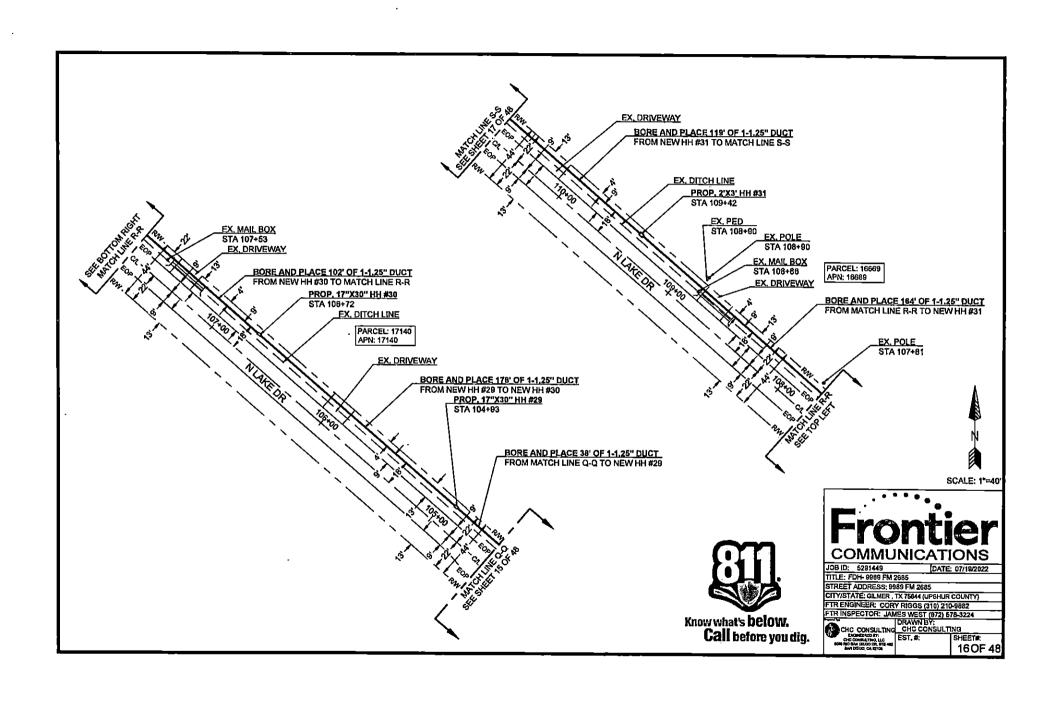





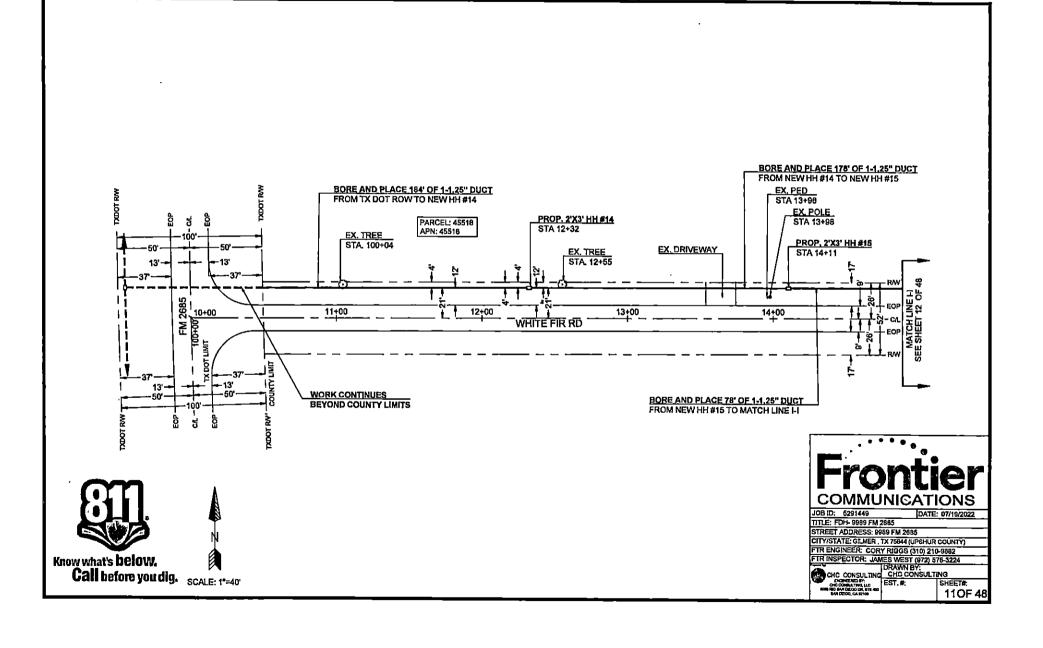


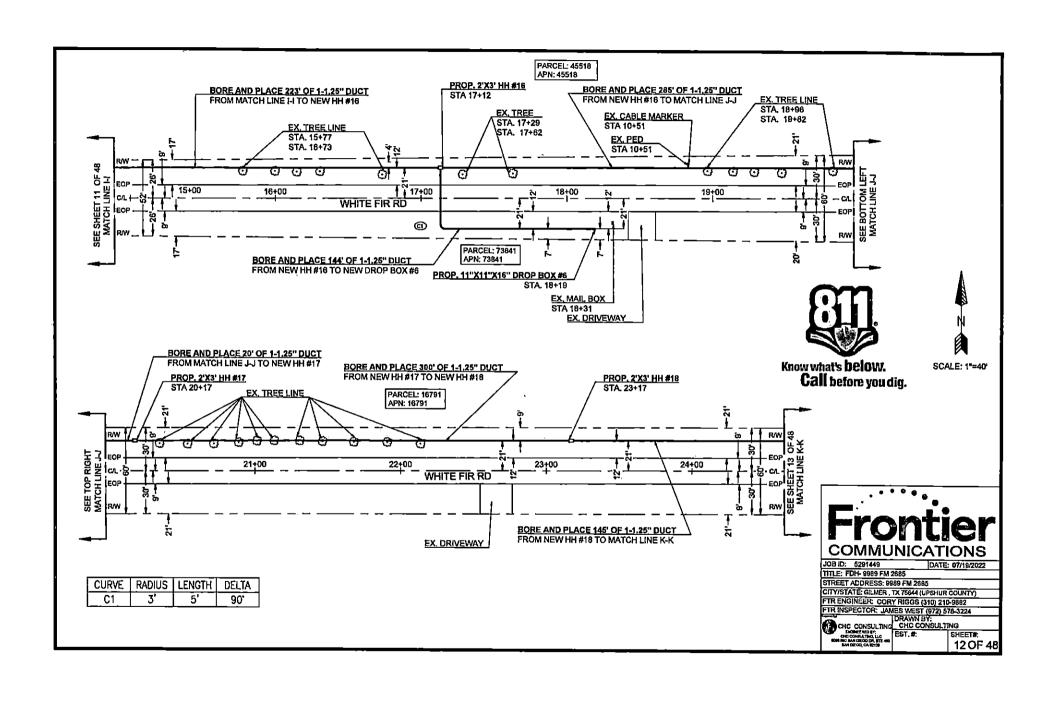


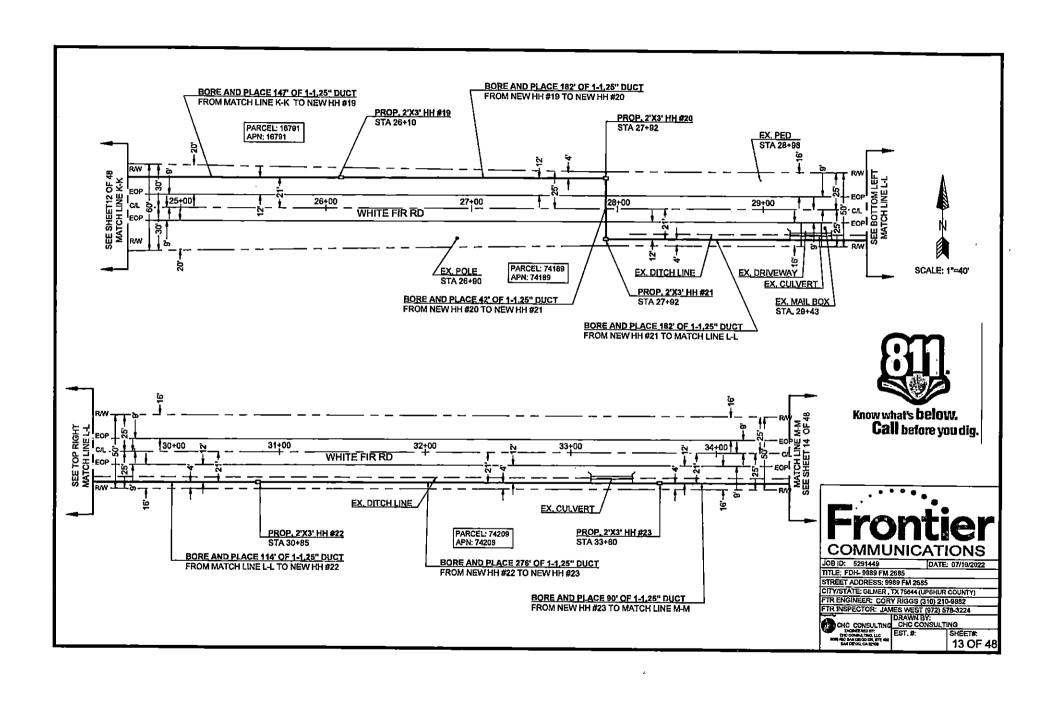


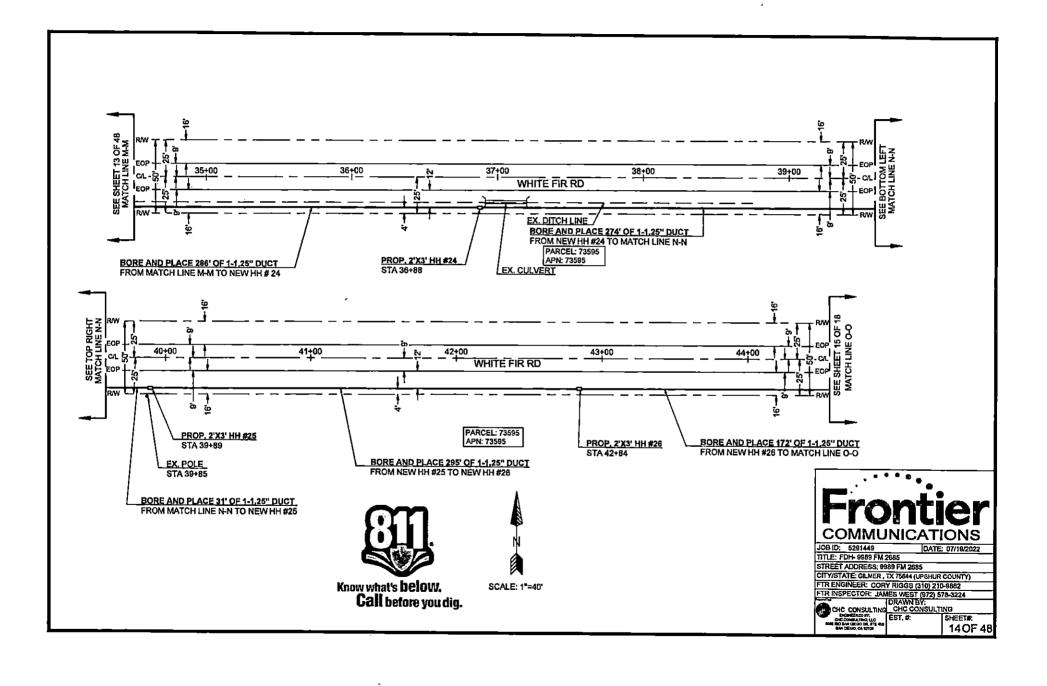


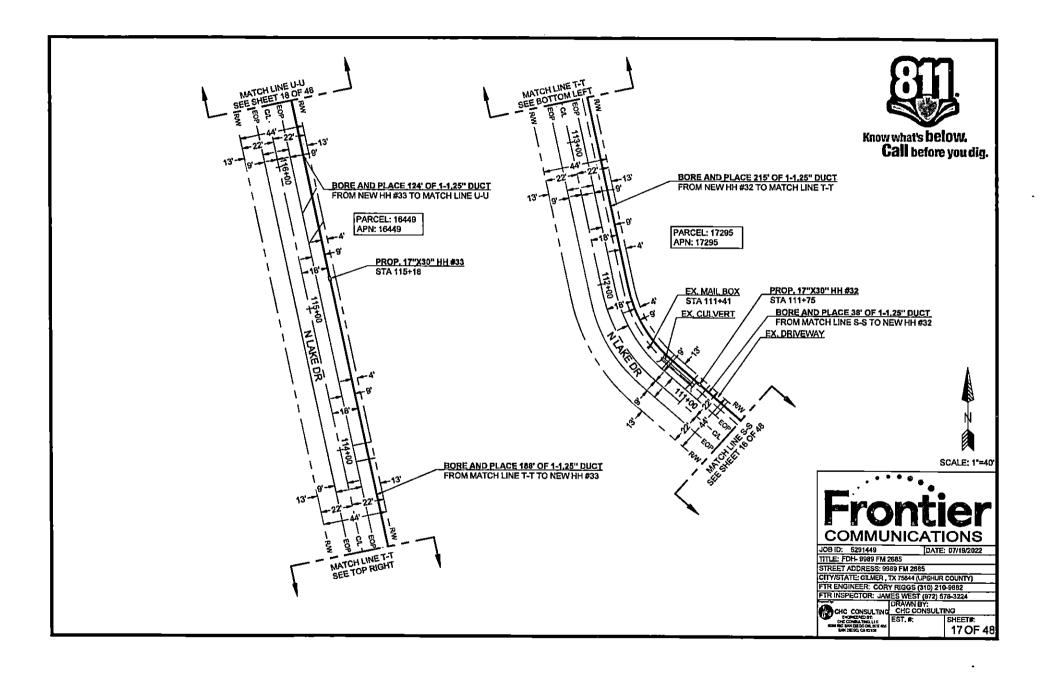


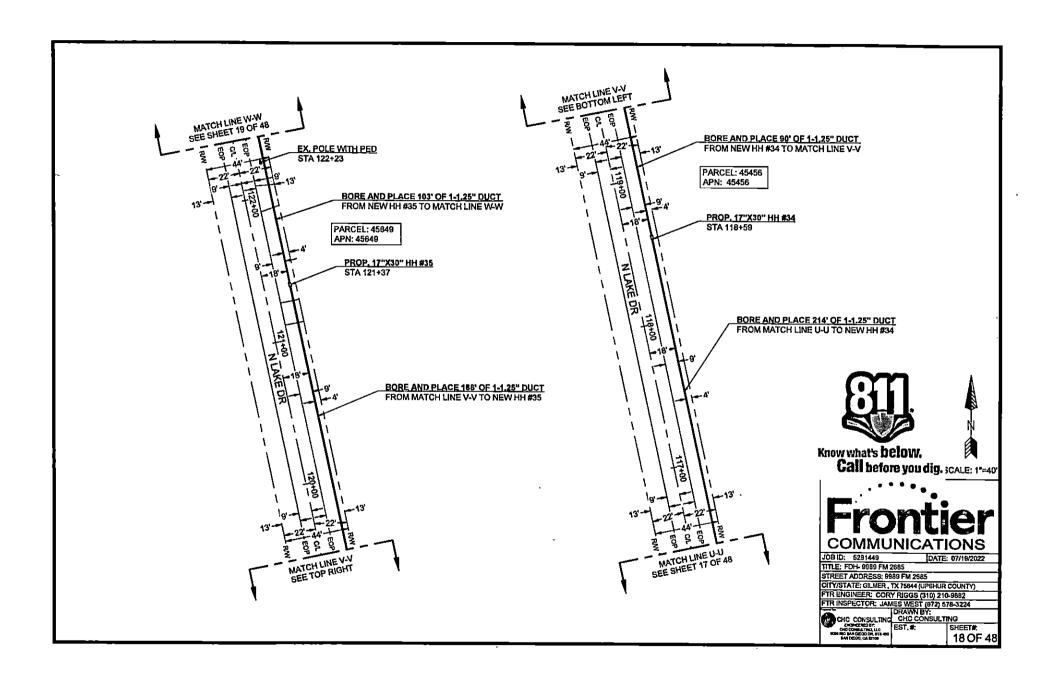


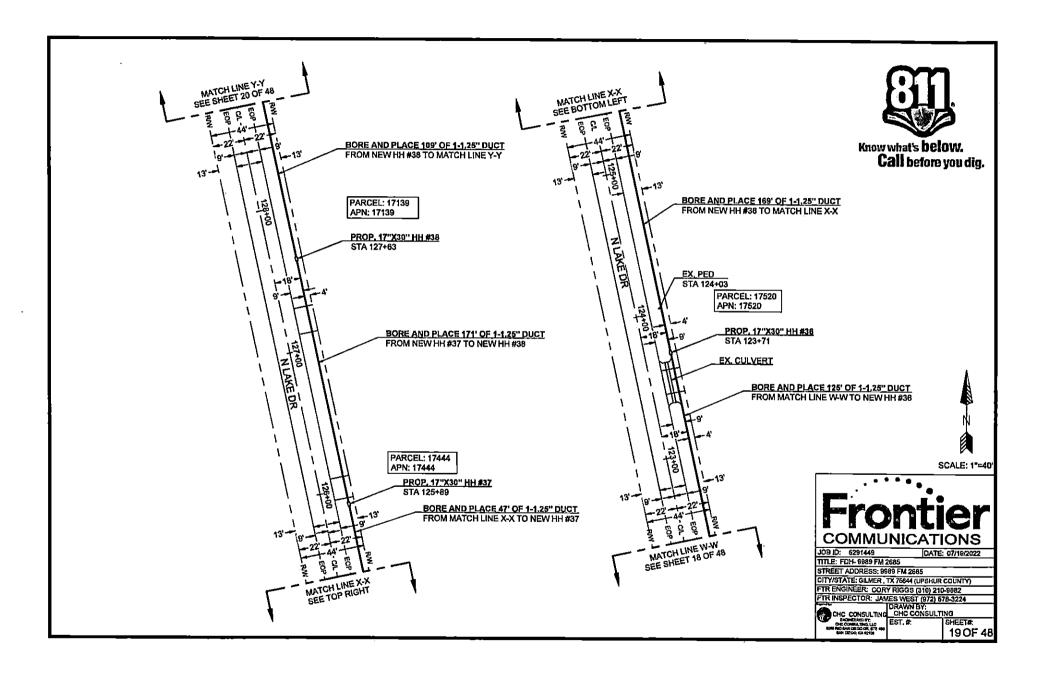


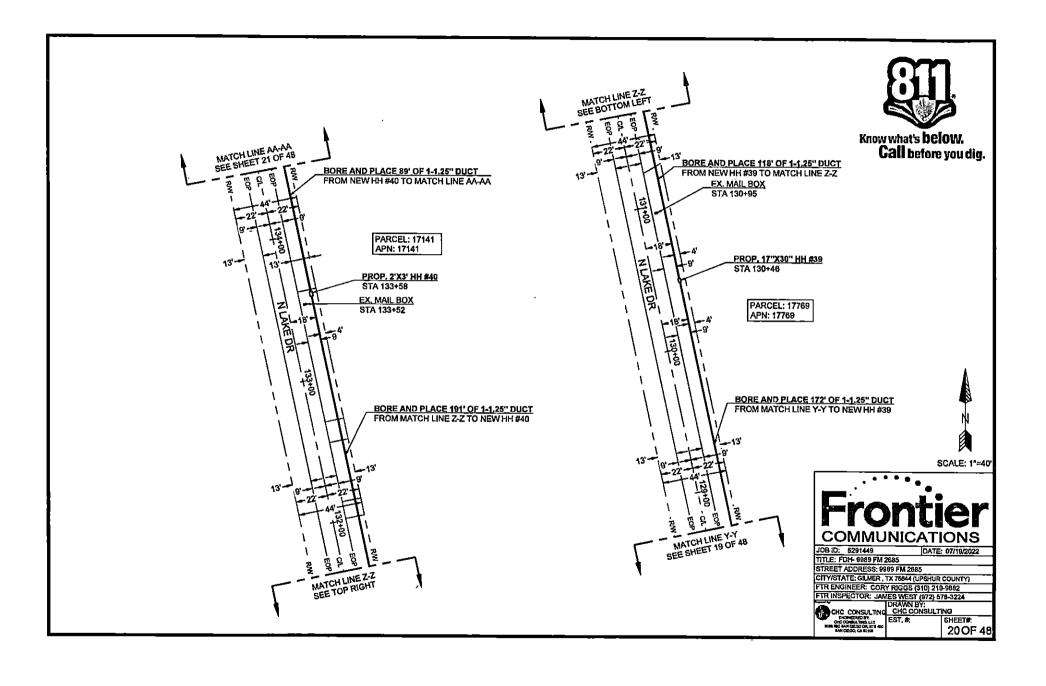


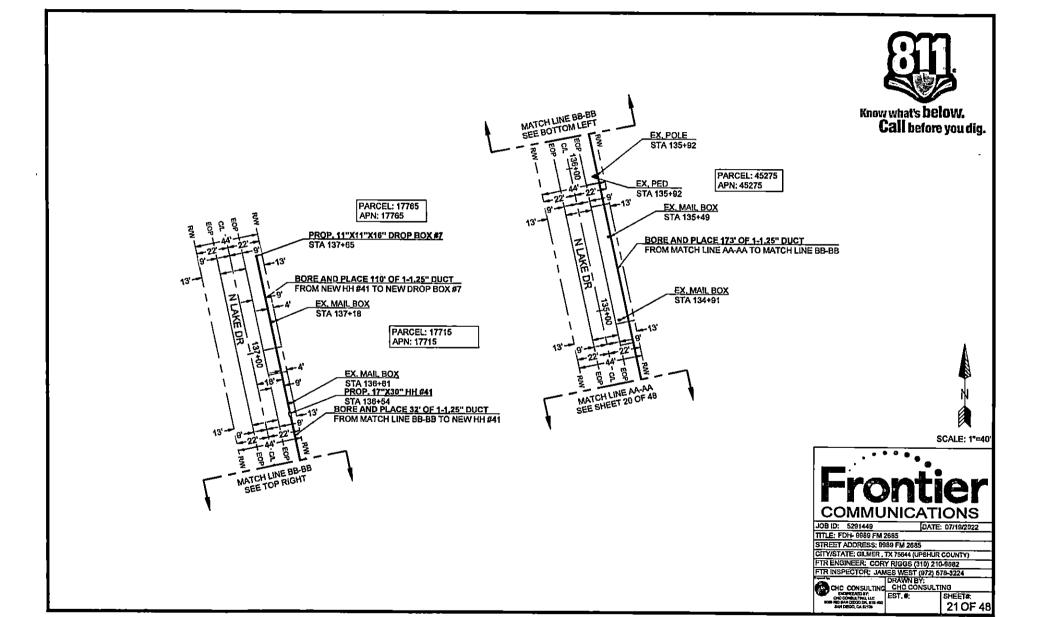


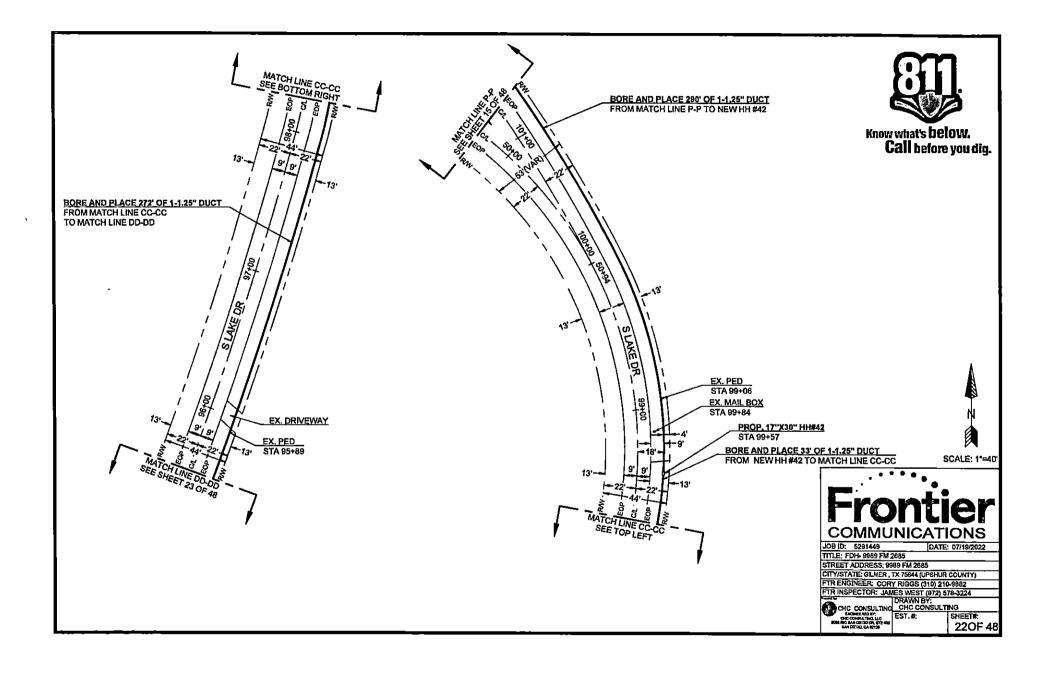


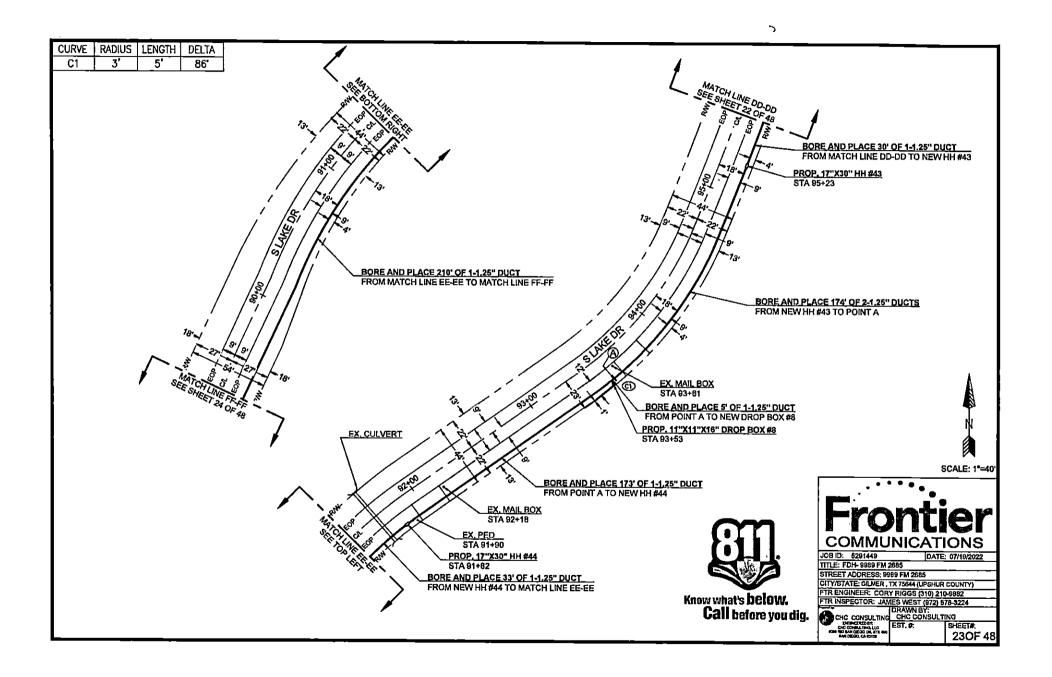


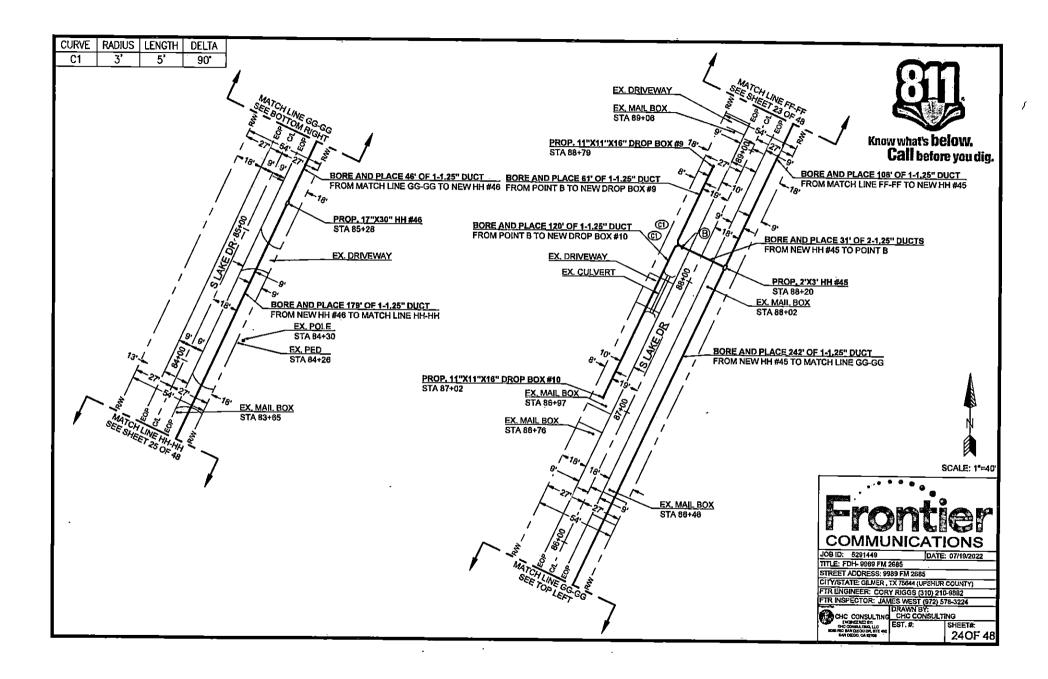

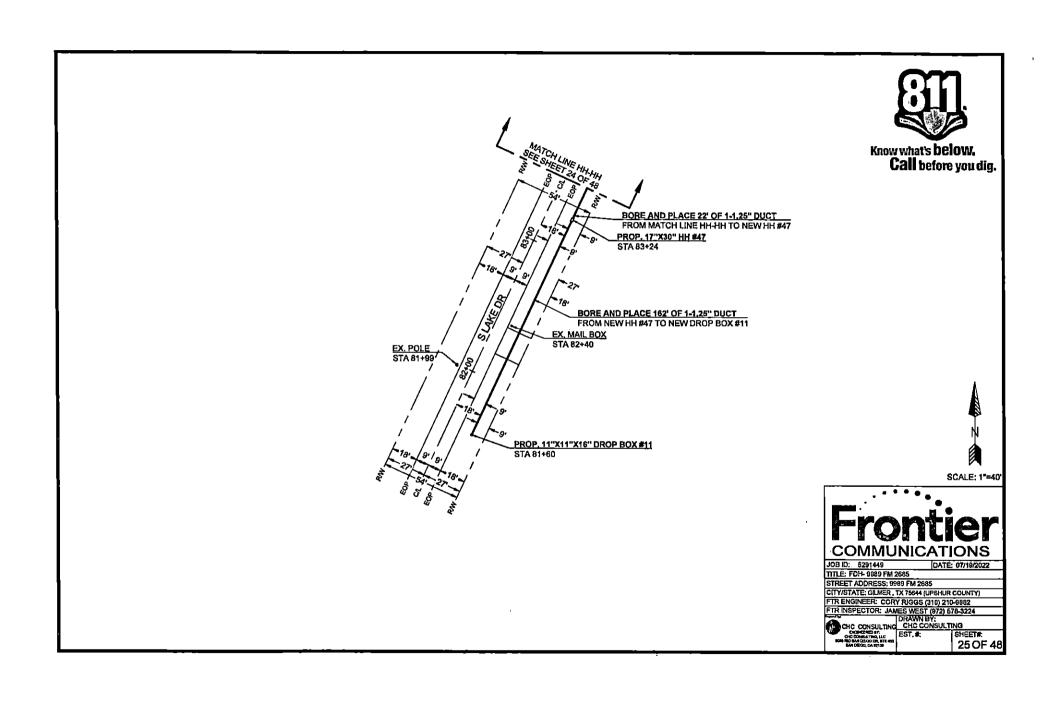

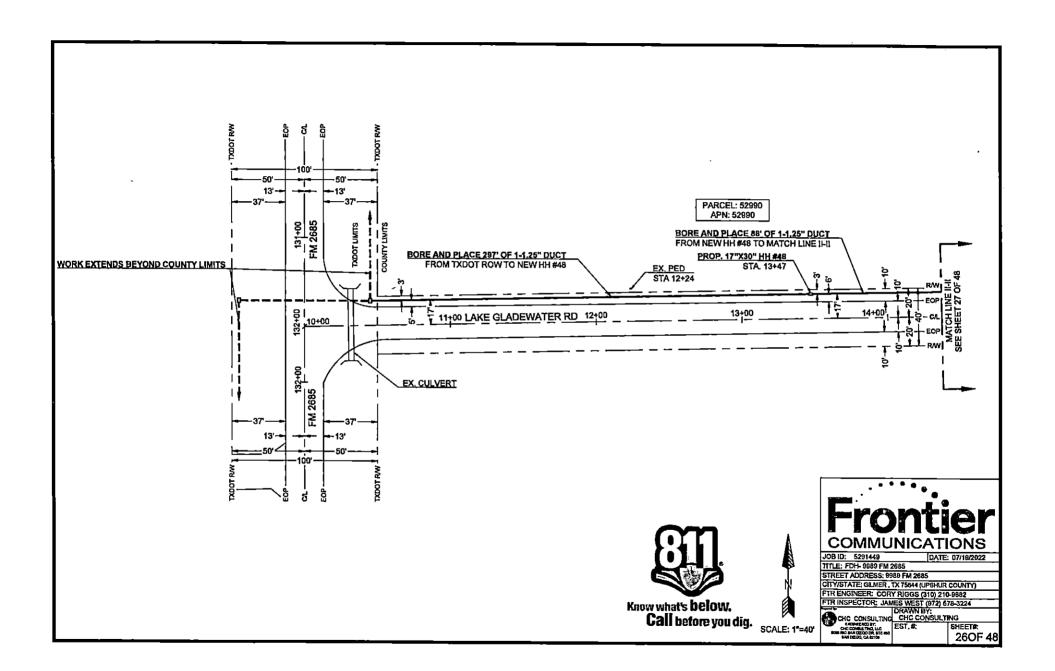

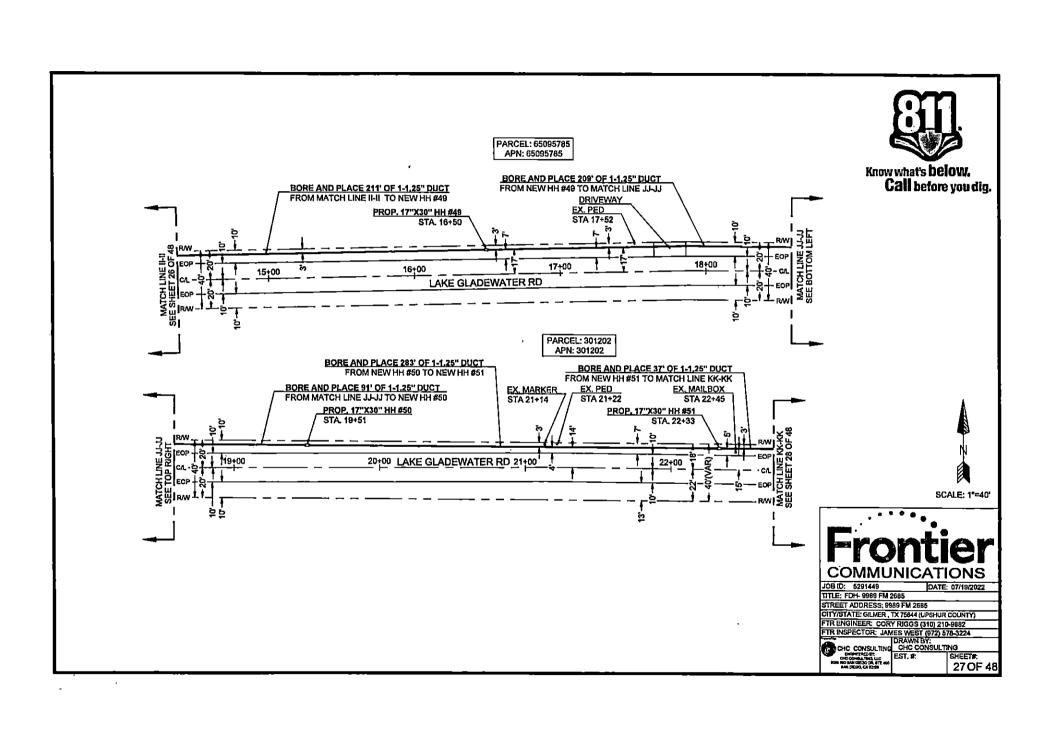

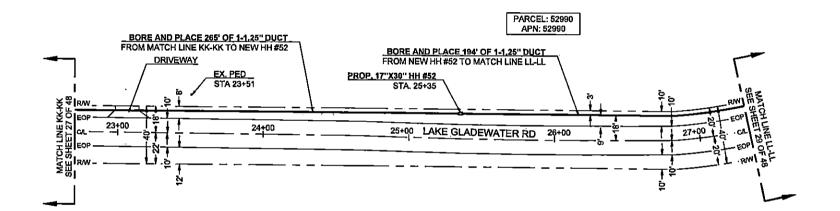










JOB ID: 5291449 TITLE: FDH- 9989 FM 2685 DATE: 07/19/2022


STREET ADDRESS: 9989 FM 2685

STREET ADDRESS: 9889 FM 2885
CITY/STATE: GILNER, TX 75644 (UPSHUR COUNTY)
FIT ENGINEER: CORY RIGGS (310) 210-9882
FIT INSPECTOR: JAMES WEST (972) 576-3224
DRAWN BY:
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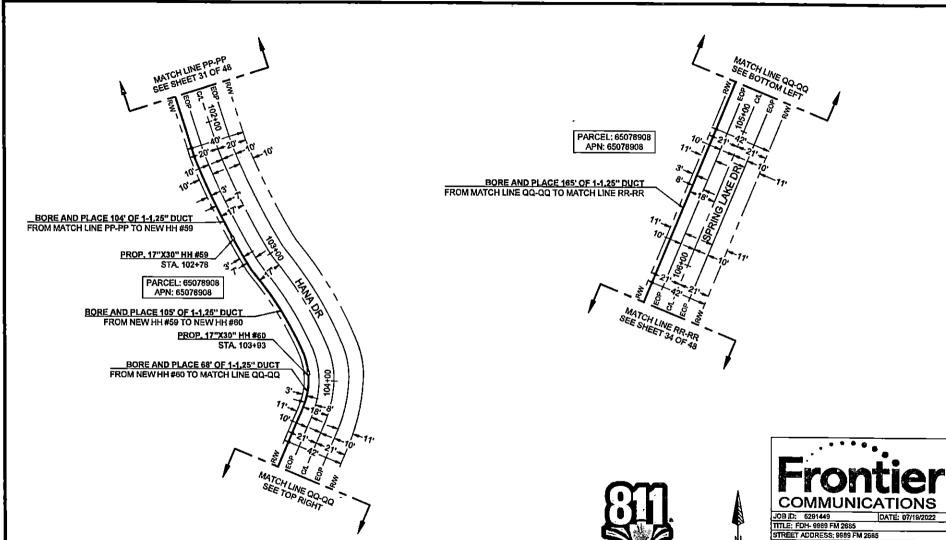


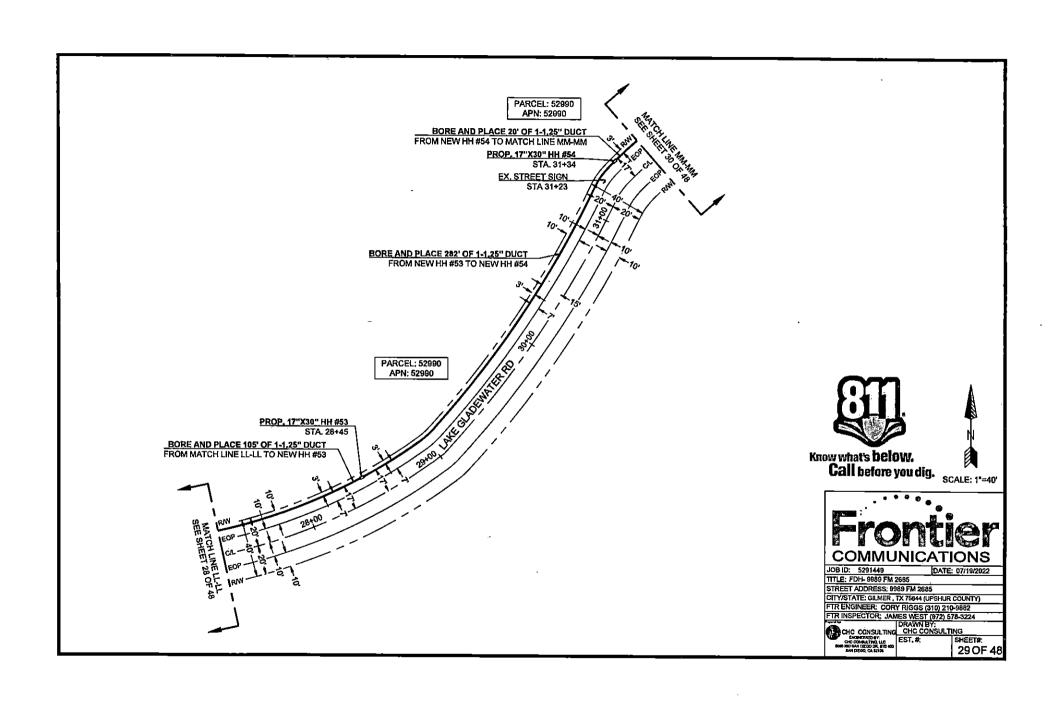

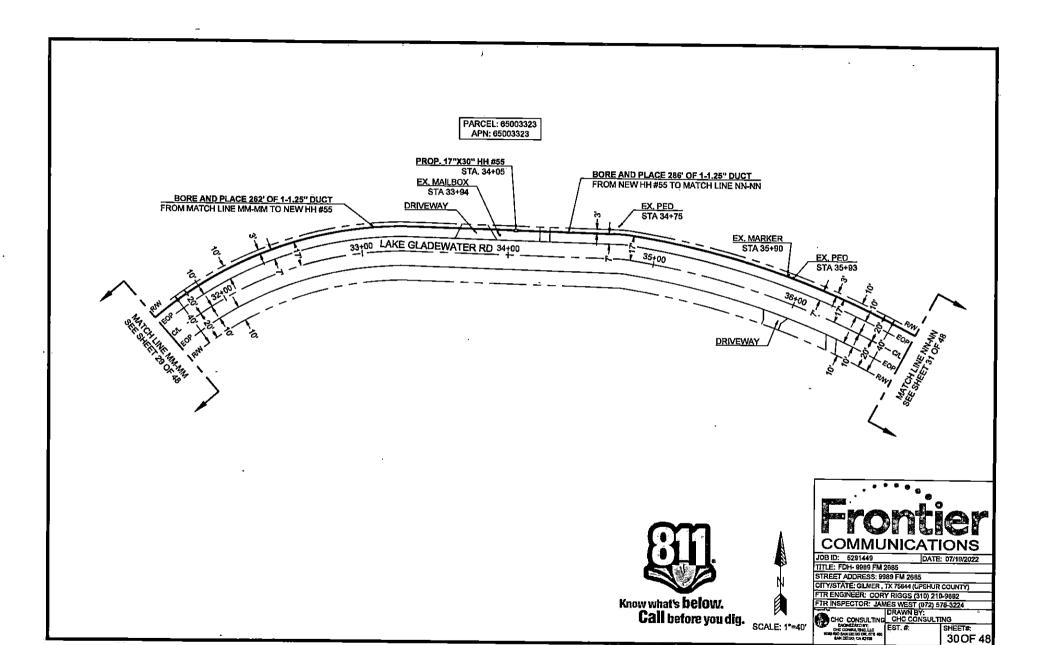DATE: 07/19/2022

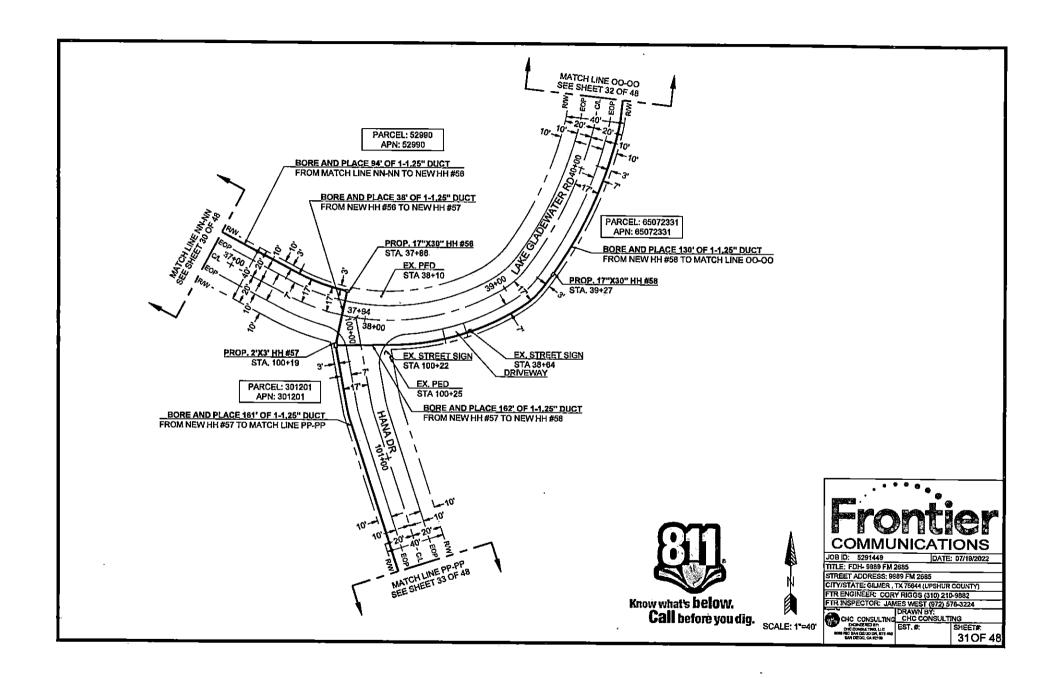JOB ID: 5291449 DATE: 07/19/2022
TITLE: FDH- 9889 FM 2685
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CITY/STATE: GLMER, TX 75944 (UPSHUR COUNTY)
FTR ENGINEER: CORY RIGGS (310) 210-9882
FTR INSPECTOR: JAMES WEST (972) 578-3224
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32 OF

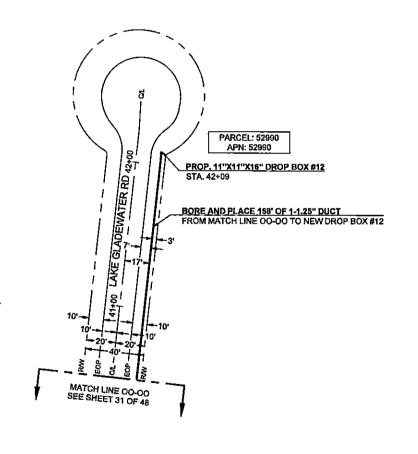SHEET#: 32 OF 48












STHEET ADDRESS: 9889 FM 2885
CITY/STATE: GILMER, TX 75644 (UPBIUR COUNTY)
FIR ENGINEER: CORY RIGOS (310) 210-9882
FTR INSPECTOR: JAMES WEST (972) 578-3224
DRAWN BY:
CHC CONSULTING
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SOURCE CONSULTING
STREET CONSULTING
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CURVE	RADIUS	LENGTH	DELTA
C1	3'	5'	90.

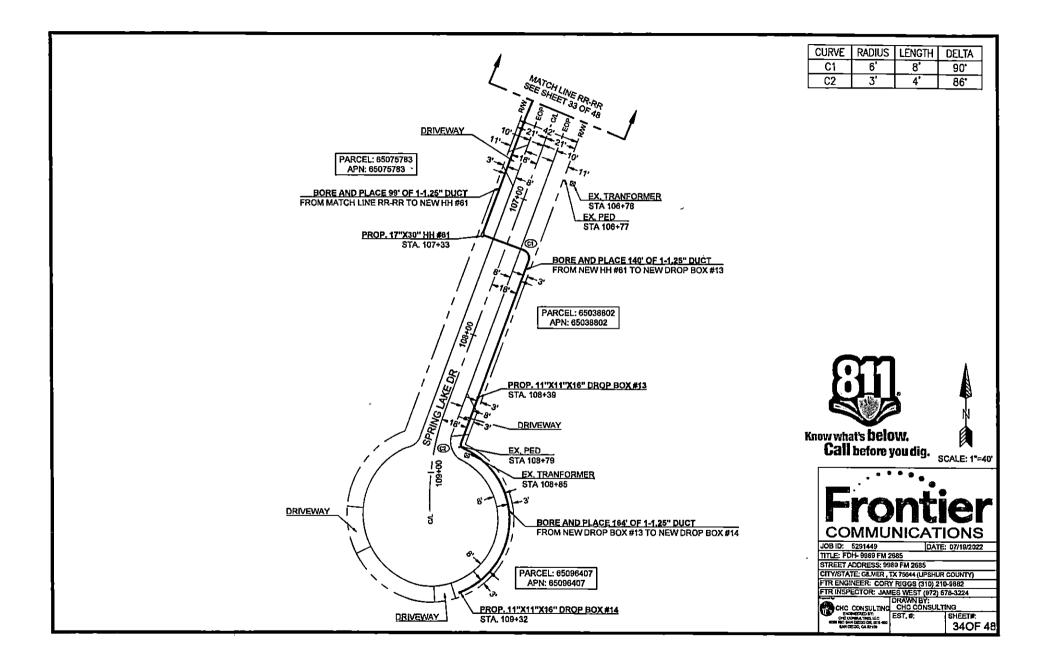

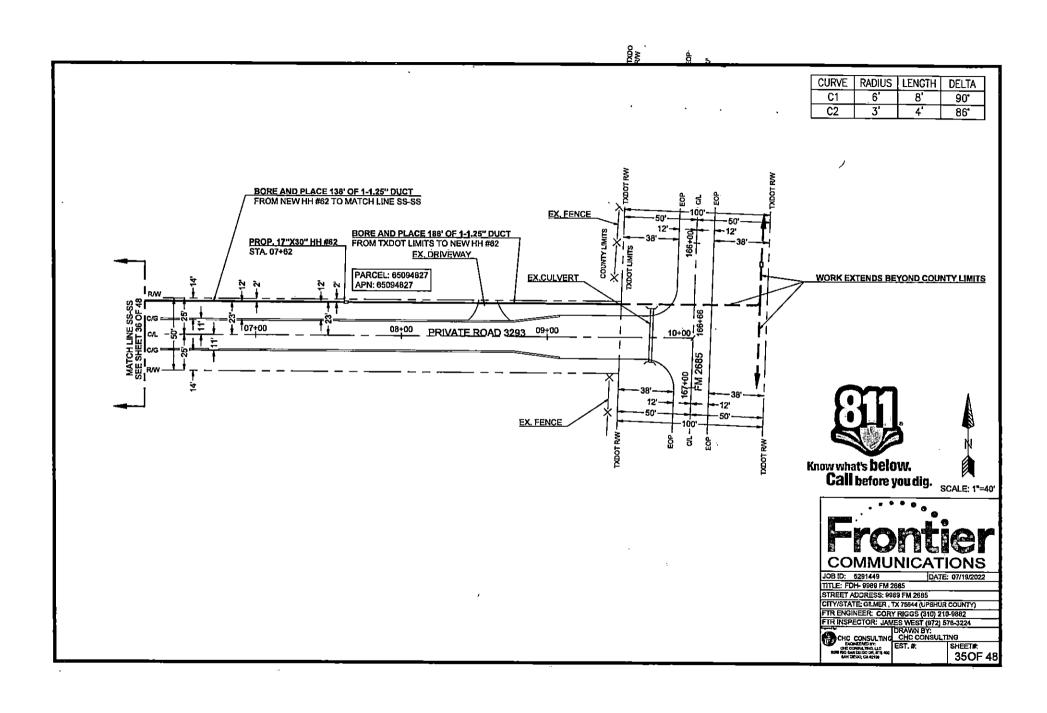

SCALE: 1"=40"

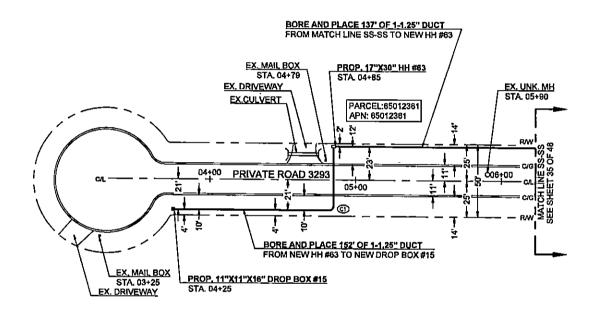





JOB ID: 5291449 TITLE: FDH- 9989 FM 2685 DATE: 07/19/2022

STREET ADDRESS; 9989 FM 2685


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CITY/STATE: GILMER, TX 75644 (UPSHUR COUNTY)
FTR ENGINEER: CORY RIGGS (310) 210-9882
FTR INSPECTOR: JAMES WEST (872) 578-3224
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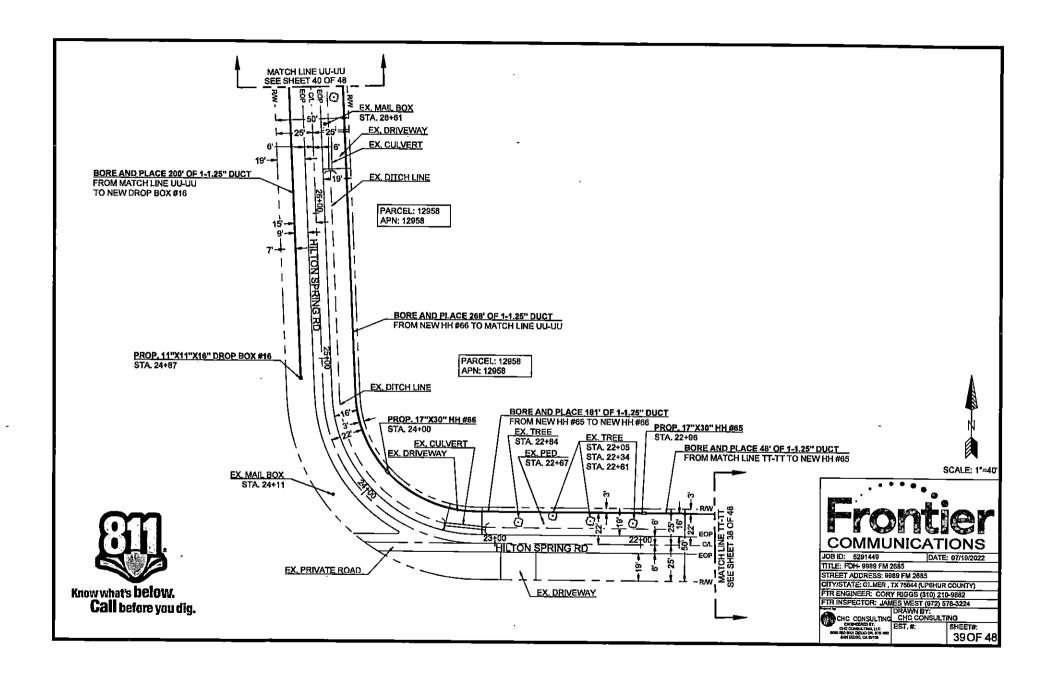


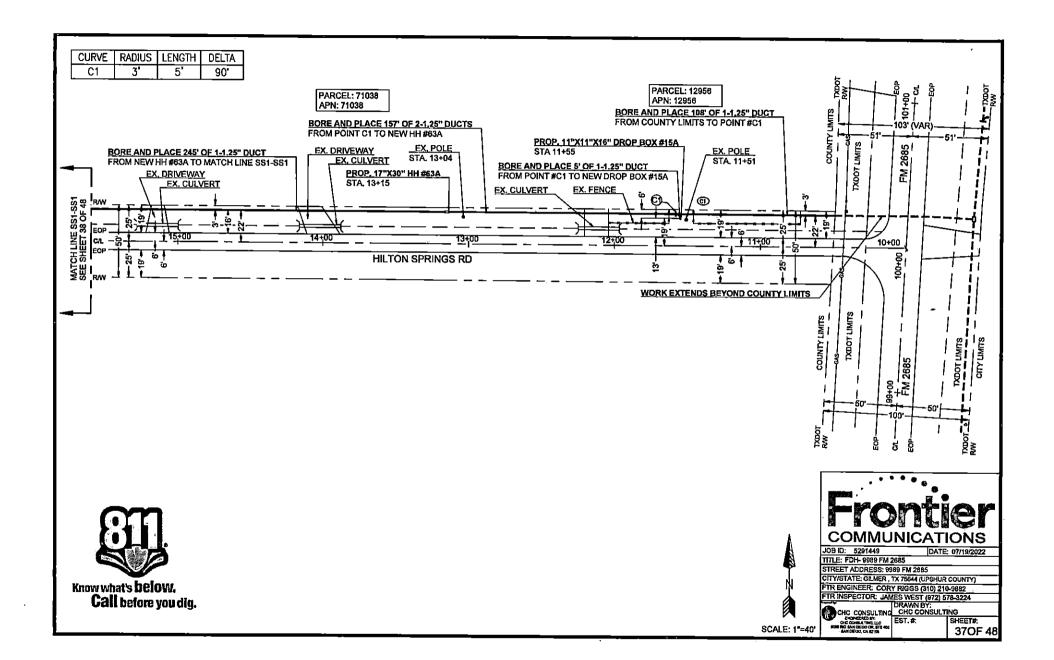


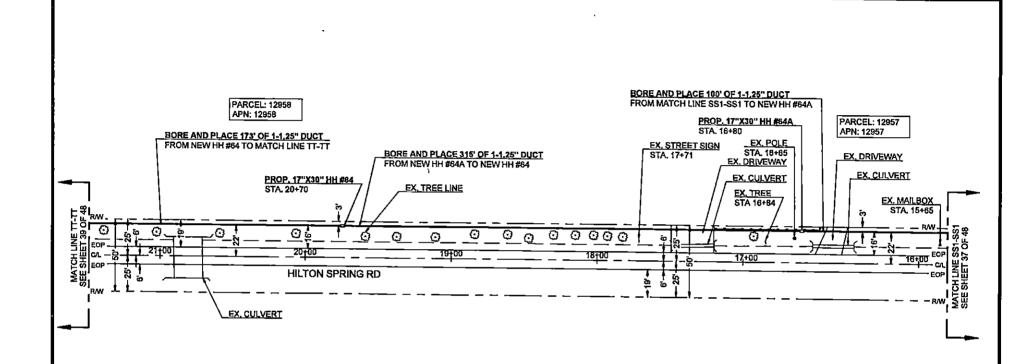








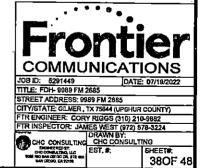


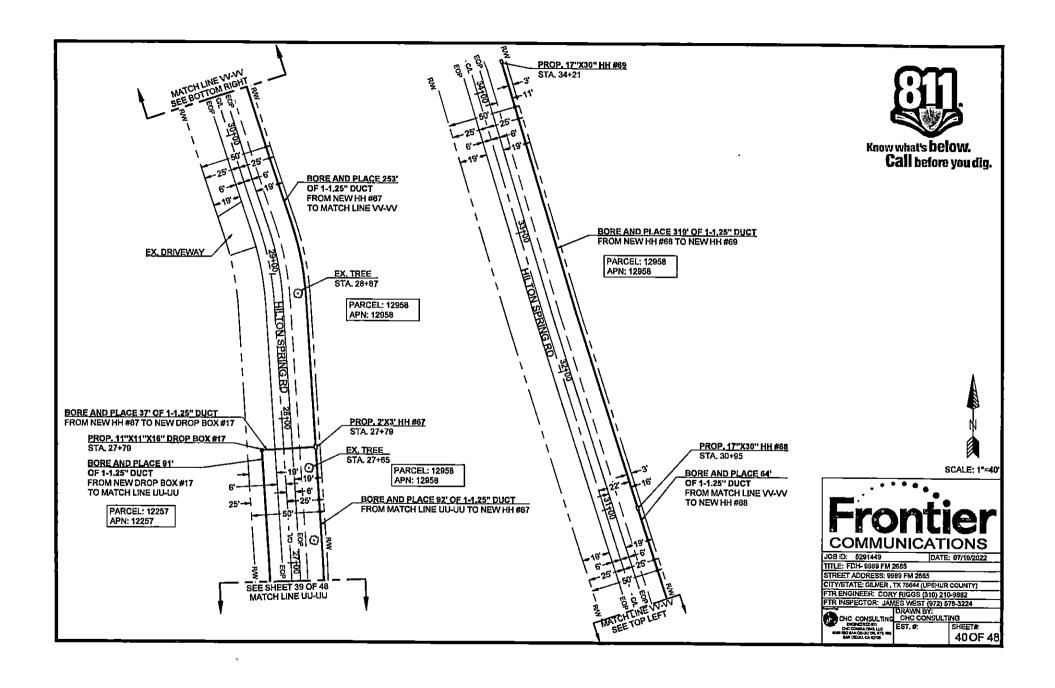


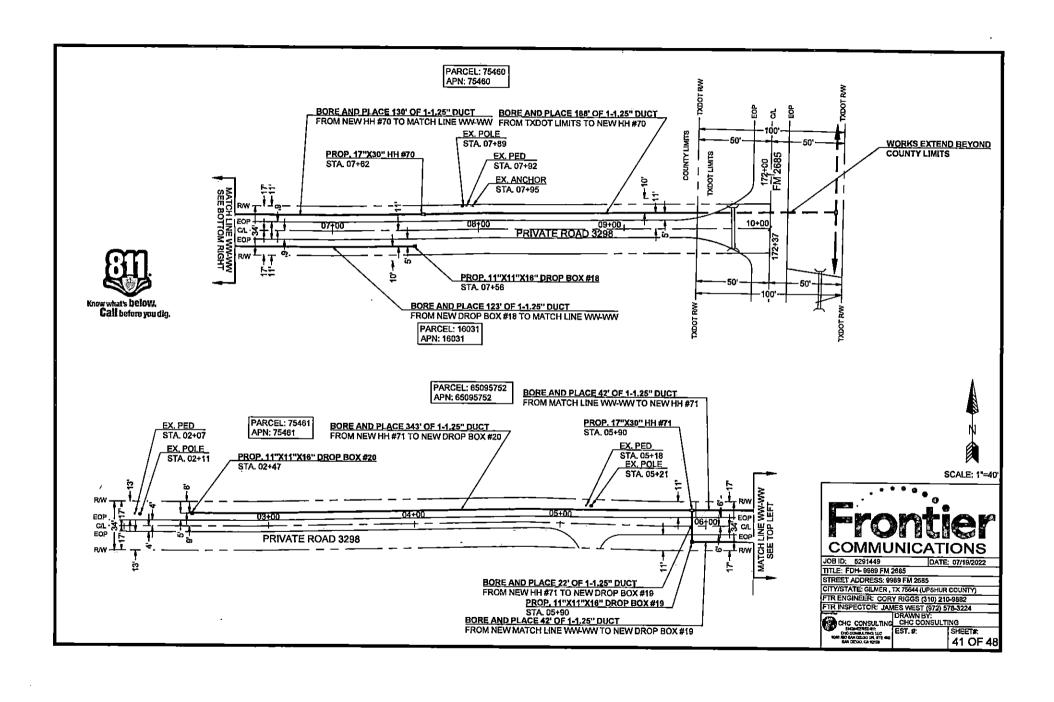


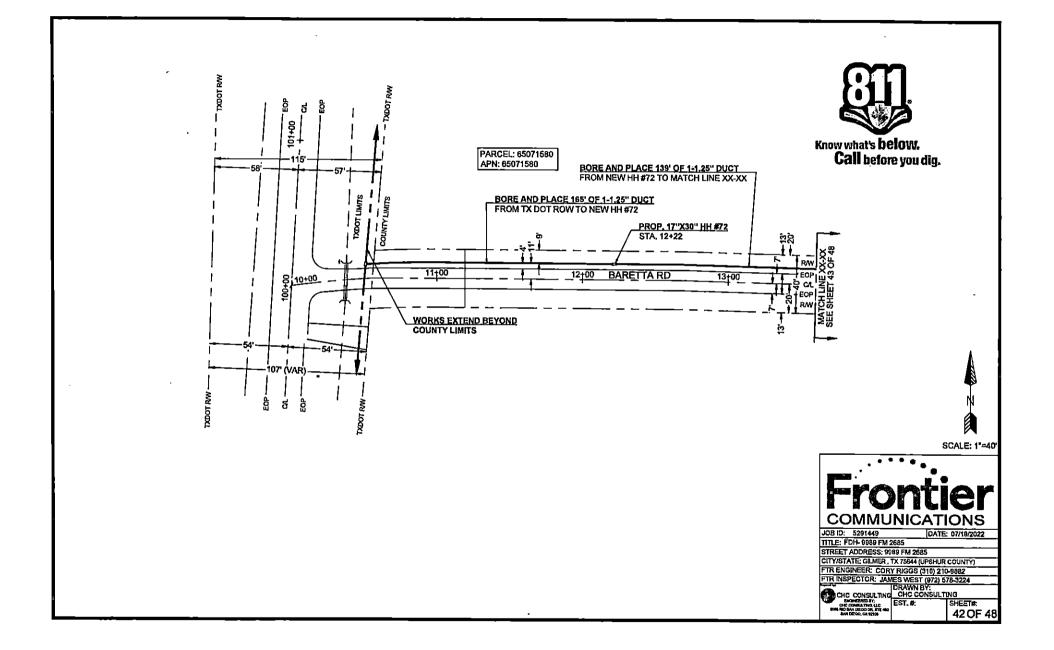


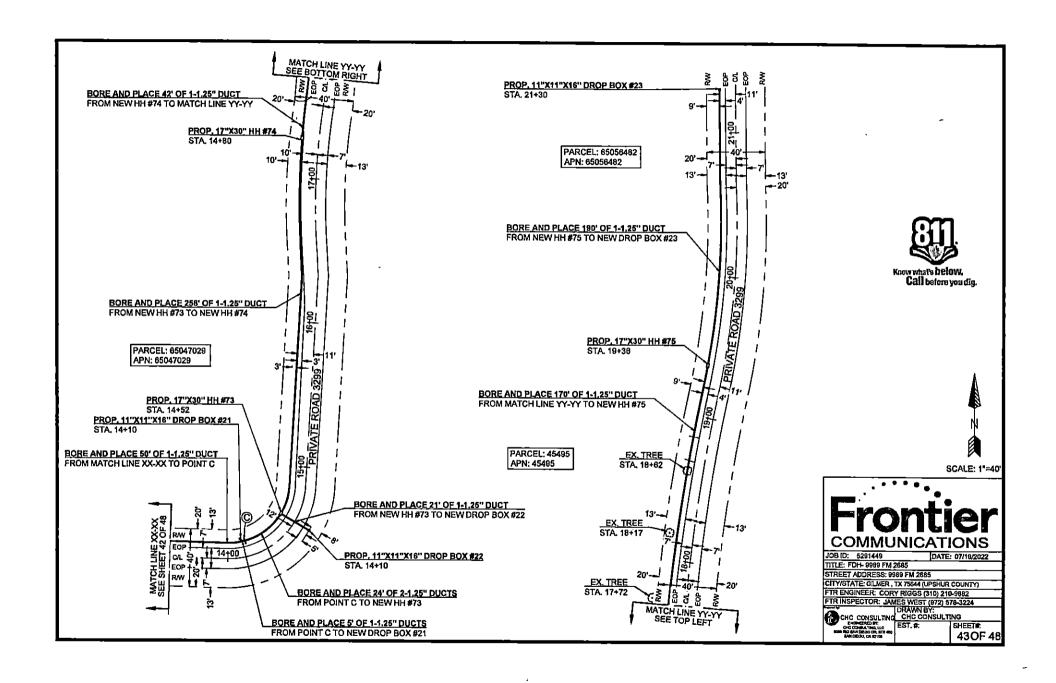

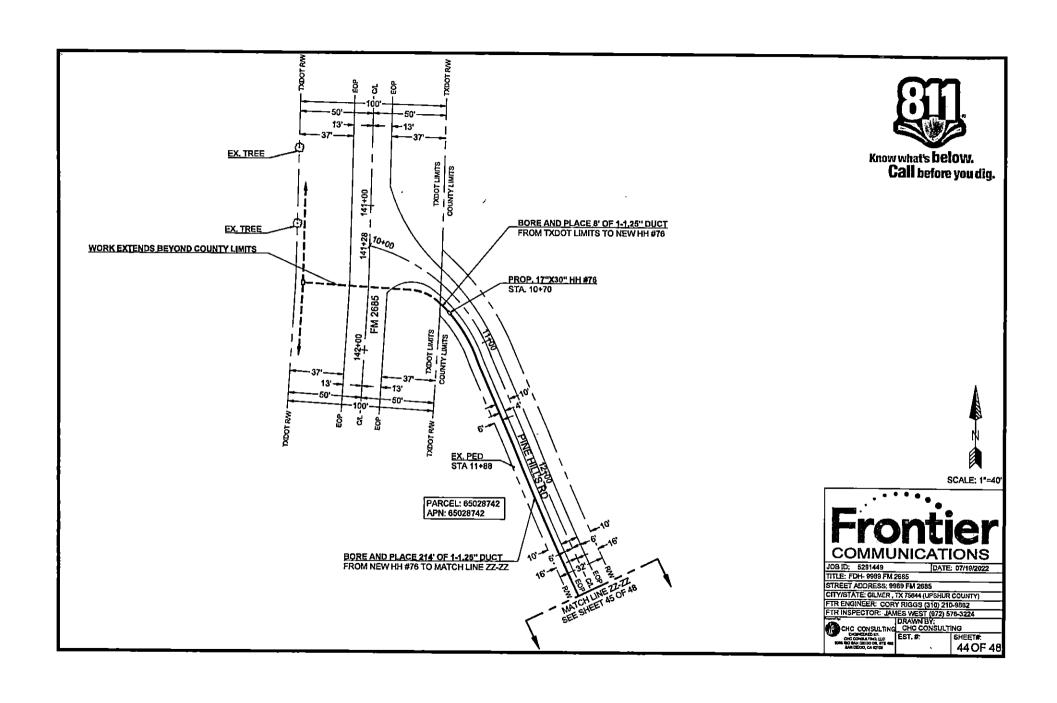


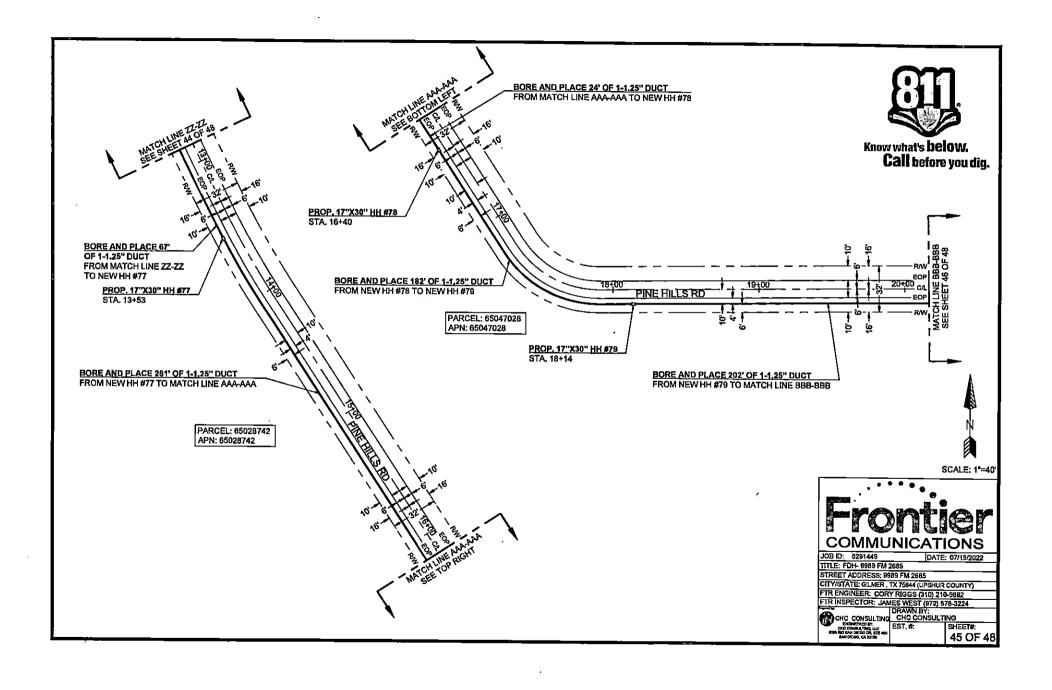

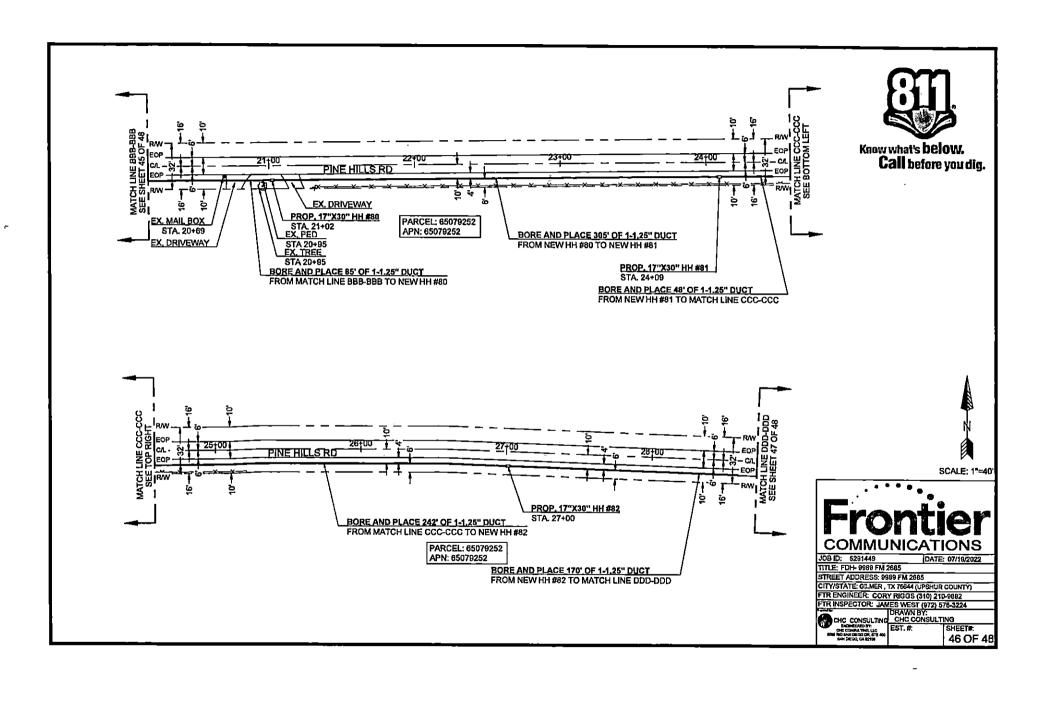


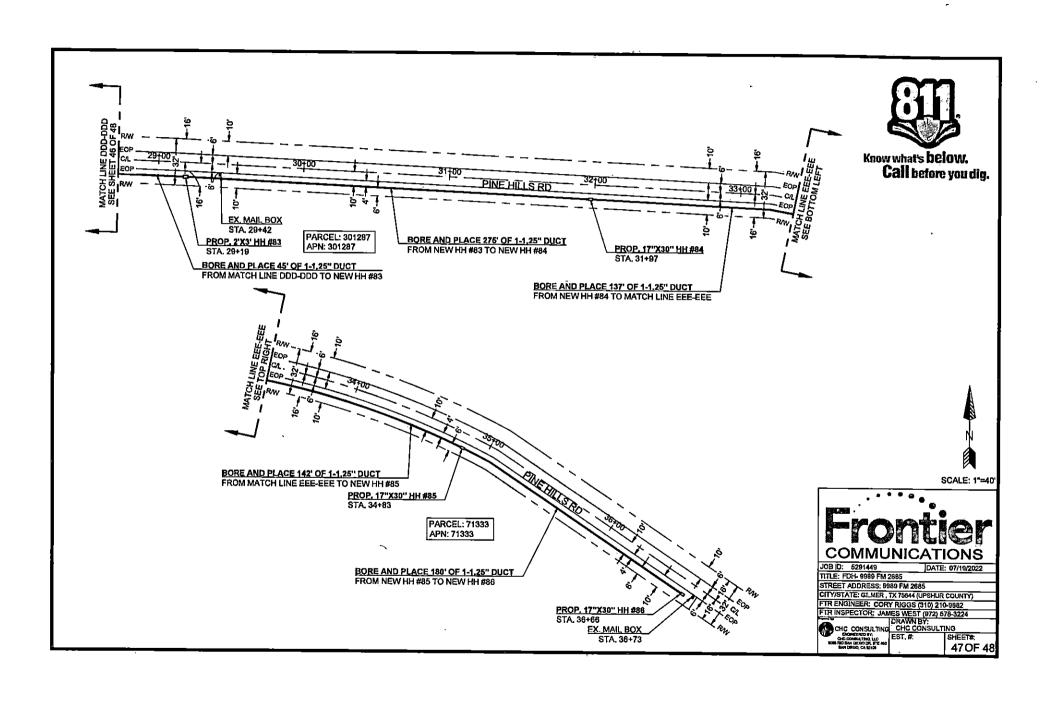




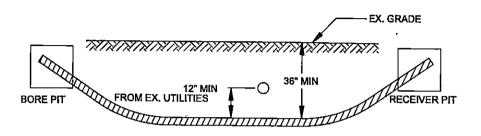

- PLACE END MARKER WITH UTILITY OWNER'S NAME DESCRIBING CONDUIT BORE PIT TO BE BACKFILLED AND COMPACTED IN 12" LIFTS WITH MATERIAL REMOVED
- FLOW OF DITCH MUST BE MAINTAINED AT ALL TIMES
- PROTECT ROOTS AT ALL TREE LOCATIONS, SHIFT BORE TRENCH IF NECESSARY

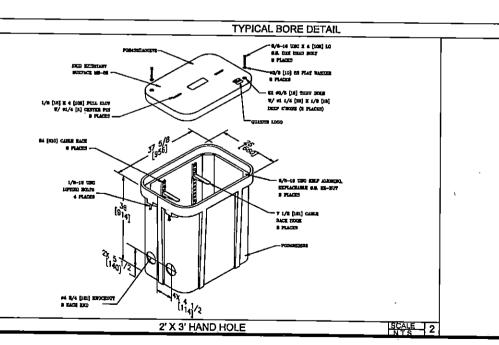

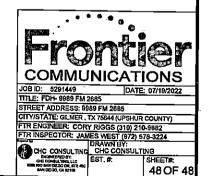

48 OF 48

SCALE 1

APPROVAL

TO: Etex Telephone Coop.,Inc	DATE <u>7/25/2022</u>
P.O. Box 130 Gilmer Texas 75644	
Gillier Xexas 75044	
The Upshur County Commissioners Court offers no objection Fiber Optic line across Martin Ln, Green Hills and Stoney Ln. as s 7/25/2022 , except as note N/A	ns to the location on the right-of-way of your proposed New shown by accompanying drawings and notice dated _
It is expressly understood that the Upshur County Commissioners County casement in or upon this county road; and it is further understood that improve, relocate, widen, increase add to or any manner change the st moved under the direction of the Upshur County Engineer and shall be shall be notified a minimum of 48 hours prior to the beginning of any	in the future should for any reason Upshur County need to work, ructure of this right-of-way line, this line, if affected, will be relocated at the complete expense of the owner. Upshur County
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1. All ground lines are to be installed a minimum of 36 inches below	the flowline of the adjacent drainage or borrow ditch.
2. All excavations within the right-of-way and not under surfacing sha surplus material shall be removed from the right-of-way and the excav	
3. Lines crossing under surfaced roads and under surfaced cross roads shall extend from crown line to crown line.	s within the right-of-way shall be placed by boring. Boring
4. All lines under roads carrying pressure in excess of 50 psi shall be line to right-of-way line. Pipe used for casing may be of any type approxupporting the load of roadbed and traffic and shall be so constructed for its entire length. Inside diameter of casing shall be at least 2 inche couplings. (Encasement is not required on lines installed 48 inches or	roved by the County Engineer and shall be capable of that there will be no leakage of any matter through the casing s greater than the largest outside diameter of carrier pipe, joint or
5. All lines, where practicable, shall be located to cross roadbed at ap under or within 50 feet of either end of a bridge unless approved by th any culvert or within 10 feet of the closest point of same.	
6. Parallel lines will be installed as near the right-of-way lines as is postetween the drainage ditch and roadbed unless approved by the Count	essible and no parallel line will be installed in the roadbed or y Engineer in writing.
7. Overhead lines will have a minimum clearance of 18 feet above the	road surface at point of crossing.
8. Operations along roadways shall be performed in such a manner th times, as well as all operating equipment and materials. Do not use equipment of structure. The cost of any repairs to road surfaces, roadbed installation will be borne by the owner of this line.	uipment or installation procedures which will damage any road
9. Barricades, warning signs, lights and flagmen, when necessary, sha traveled portion of the road must be open to traffic at all times. All trathe current version of the Texas MUTCD.	
10. Utility company shall install adequate erosion control measures for	any excavation work being performed.
APPROVED: APPROVED: APPROVED OF PROPOSES	Chairperson, Upshur County Commissioners Court
NOTICE OF PROPOSE	J ING I ALLA I IUN

Revised 11/30/10

NOTICE OF PROPOSED INSTALLATION PIPE AND/OR UTILITY LINES

DATE: 7/25/2022

TO: UPSHUR COUNTY COMMISSIONERS COURT c/o UPSHUR COUNTY ENGINEER UPSHUR COUNTY ROAD & BRIDGE DEPARTMENT P. O. BOX 730 Gilmer, TX 75644

EXPIRES: 10/25/2022

Formal notice is hereby given that Etex Telephone Coop., Inc. proposes to bore a New Fiber Optic line within the right-of-way of County Roads Martin Ln, Green Hills and Stoney Ln. as follows: All construction will be Directional Bored in at a min Depth of 48" on both sides of said roads and on the up side of ditch line with in the county right of way. Installing two 1.25" Duct with a new Fiber Optic Cable.

The location and description of the proposed line and appurtenances is more fully shown by three copies of drawings attached to this notice. The line will be constructed and maintained on the County right-of-way as directed by the County Engineer in accordance with current Upshur County specifications.

Construction of this line will begin on or after the 25 day of July, 2022 and will be completed within 90 days of the date of approval.

Firm Etex Telephone Coop., Inc.
By Martin Thompson
Title Right of way solicitor

Address P.O. Box 130 Gilmer Texas 75644

NOTE: 1. This form to be submitted in triplicate for each proposed installation.

- 2. The permit shall be in effect until the utility line is removed from the right of way.
- 3. Inform the County Engineer if work is not completed within this time

APPROVAL

DATE <u>07/15/22</u>

TO: Frontier Communications
Att: Doris Robinson
Permit Coordinator
9095 Rio San Diego Drive
San Diego, CA 92108

The Upshur County Commissioners Court offers no objections to the location on the right-of-way of your proposed project to bore, place conduit, hand holes, drop boxes and FDH as well as aerial placement at 1619 E. Lake Drive, Willow Oak Road, Pine Ridge Road and Cannon Street as shown by accompanying drawings and notice dated 04/28/22, except as noted below:

It is expressly understood that the Upshur County Commissioners Court does not purport, hereby, to grant and right, claim, title, or easement in or upon this county road; and it is further understood that in the future should for any reason Upshur County need to work, improve, relocate, widen, increase add to or any manner change the structure of this right-of-way line, this line, if affected, will be moved under the direction of the Upshur County Engineer and shall be relocated at the complete expense of the owner. Upshur County shall be notified a minimum of 48 hours prior to the beginning of any work.

All work on the county right-of-way shall be performed in accordance with the County Engineer's instructions. The installation shall not damage any part of the highway and adequate provisions must be made to cause minimum inconvenience to traffic and adjacent property owners. Special specifications for placing this line are as follows:

- 1. All ground lines are to be installed a minimum of 36 inches below the flowline of the adjacent drainage or borrow ditch.
- 2. All excavations within the right-of-way and not under surfacing shall be backfilled by tamping in 6 inch horizontal layers. All surplus material shall be removed from the right-of-way and the excavation finished flush with surrounding natural ground.
- 3. Lines crossing under surfaced roads and under surfaced cross roads within the right-of-way shall be placed by boring. Boring shall extend from crown line to crown line.
- 4. All lines under roads carrying pressure in excess of 50 psi shall be enclosed in satisfactory casing extending from right-of-way line to right-of-way line. Pipe used for casing may be of any type approved by the County Engineer and shall be capable of Supporting the load of roadbed and traffic and shall be so constructed that there will be no leakage of any matter through the casing for its entire length. Inside diameter of casing shall be at least 2 inches greater than the largest outside diameter of carrier pipe, joint or couplings. (Encasement is not required on lines installed 48 inches or greater below flowline.)
- 5. All lines, where practicable, shall be located to cross roadbed at approximately right angles thereto. No lines are to be installed under or within 50 feet of either end of a bridge unless approved by the County Engineer in writing. No lines shall be placed inside any culvert or within 10 feet of the closest point of same.
- 6. Parallel lines will be installed as near the right-of-way lines as is possible and no parallel line will be installed in the roadbed or between the drainage ditch and roadbed unless approved by the County Engineer in writing.
- 7. Overhead lines will have a minimum clearance of 18 feet above the road surface at point of crossing.
- 8. Operations along roadways shall be performed in such a manner that all excavated material be kept off the pavements at all times, as well as all operating equipment and materials. Do not use equipment or installation procedures which will damage any road surface or structure. The cost of any repairs to road surfaces, roadbed, structures or other right-of-way features as direct result of this installation will be borne by the owner of this line.
- 9. Barricades, warning signs, lights and flagmen, when necessary, shall be provided by the contractor or owner. One half of the traveled portion of the road must be open to traffic at all times. All traffic control shall be in accordance with the requirements of the current version of the Texas MUTCD.
- 10. Utility company shall install adequate erosion control measures for any excavation work being performed.

APPROVED:	Road Administrator	APPROVED: Chairnerson Unshur County Commissioners Court
APPROVED:	Road Administrator	APPROVED: Chairperson, Upshur County Commissioners Court

NOTICE OF PROPOSED INSTALLATION PIPE AND/OR UTILITY LINES

TO: UPSHUR COUNTY COMMISSIONERS COURT c/o UPSHUR COUNTY ENGINEER UPSHUR COUNTY ROAD & BRIDGE DEPARTMENT P. O. BOX 730 Gilmer, TX 75644		DATE: EXPIRES:	
Formal notice is has follows:	ereby given thatproposes to bore a	_ line within the right-of-way of County Road	
1st package:	(1) NEW PAD MOUNT FDH 288, (1) NEW)-1.25" DUCTS, 12' OF (3)-1.25" DUCTS,5' OF (1)-4" DUCT, 7 20"X40"X6" CONCRETE PAD, (1) NEW 3'X3' HH, 1EW 17"X30" HH, 20) NEW 2'X3' HH, AS WELL AS AERIAI	
,			
znu package:	2'X3' HH. ***5291557***	W 11"X11"X16" DROP BOX, (7) NEW 17"X30" HH, (1) NEW	
attached to this no County Engineer i	tice. The line will be constructed and maintain accordance with current Upshur County species line will begin on or after the day of		
garys or say gares o	Firm Frontier (By <u>Doris</u> Rob. Title <u>Permit</u> Co		
NOTE: 1. This 2. The	form to be submitted in triplicate for each proppermit shall be in effect until the utility line is r	nosed installation. emoved from the right of way.	

3. Inform the County Engineer if work is not completed within this time.

FRONTIER COMMUNICATION CONSTRUCTION SPECIFICATIONS

- Contact Frontier Engineer CORY RIGGS (310) 210-9882 stdy (60) days prior to need of service in order to confirm compliance, order materials, and schedule work forces, NOTE: FRONTIER COMMUNICATIONS, INCORPORATED, RESERVES THE RIGHT TO REFUSE ANY CONDUIT, PULL BOXES, MANHOLES, OR UTILITY BOXES THAT DEVIATE FROM PLANS AND SPECIFICATIONS.
- All conduit riser bends to have a minimum thirty-six (36) inch radius.
- All horizontal ninety (90) degree bends shall have a minimum radius of 12.5 feet and all vertical ninety (90) degree bends shall have a minimum radius of three feet. No more than two ninety (90) degree horizontal bends shall be placed in any single run unless otherwise specified. Contact the Frontier engineer concerning any required deviations.
- All conduit must be proven using a mandrel no less than a 1/2" smaller than the conduit placed. Wall to wall measurements must be taken with a measured tage and a 3/8" polypropylene pull rope in each duct. An accurate wall to wall measurement of conduit placed must be As-built on an approved Frontier construction plan. A copy of the As-built conduit work order must be provided to the Frontier inspector assigned to your project.
- Piece weatherproof caps on all terminated conduits.
- Approved plastic conduit (PVC Sch. 40,TYPE-C or HDPE (27) is to be used in underground construction unless otherwise specified.
- Conduit terminated on a pole must be PVC Sch. 80, Location of riser on pole will be called out by engineering on the construction plan.
- Conduit placed in same trench with primary power conduit must be separated by a minimum of twelve (12) inches of well-packed sand or three inches of concrete, and have a minimum of thirty-six (38) inches of cover when placed behind curb face. All street crossings and conduits placed in the driven portion of the roadway must have a minimum of forty-eight (48) inches of cover to top of pipe. CONTACT THE FRONTIER INSPECTOR 48 HOURS BEFORE TRENCHING AND UPON COMPLETION OF YOUR SUBSTRUCTURES. TO SCHEDULE THE FINAL INSPECTION.

PERMITTING AGENCY: UPSHUR COUNTY

PICK UP POINT:


PATH FOOTAGE:

MATERIALS: (1) NEW 11"X11"X16" DROP BOX (7) NEW 17"X30" HH (1) NEW 2'X3' HH 1954' OF (1)-1.25° DUCT



CONSTRUCTION PACKAGE

FDH- 1619 E LAKE DR WILLOW OAK RD & PINE RIDGE RD **GLADEWATER, TX 75647**

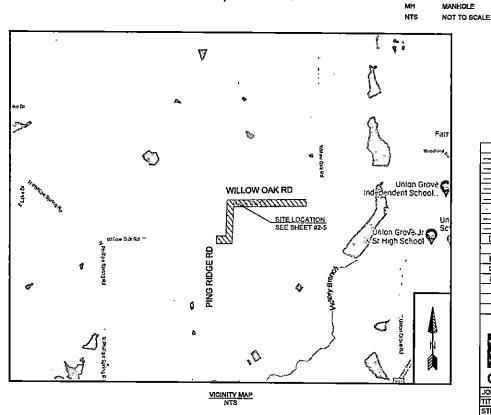

-HOPE AND PVC FOOTAGES DO NOT INCLUDE SWEEPS -ACTUAL FOOTAGES OF HOPE AND PVC WILL BE NEEDED TO ORDER MATERIALS, PLEASE INCLUDE MEASURED TAPE IN ALL PVCS. -FRONTIER INSPECTOR SHALL BE PRESENT ON SITE WHEN CONTRACTOR NEEDS TO ACCESS ANY EXISTING FRONTIER FACILITY.

ABBREVIATIONS BUILDING PED PEDESTAL (UTILITY) CENTER LINE PVC POLYVINYL CHLORIDE CONCRETE P/L PROPERTY LINE CONCRETE SIDEWALK RAILROAD RR DRIVEWAY RM RIGHT OF WAY EDGE OF CURE SL STREET LIGHT EDGE OF PAVEMENT WERLING WALL TO BUILDING PTWLINE WP WALL TO POLE

ww

BLDG

CONC

csw

DWY

EOC

EOP

ETW

HH

HANDHOLE

C/L


WALL TO WALL P.U.F. PUBLIC UTILITY EASEMENT PUBLIC SERVICE EASEMEN P.S.E. CURB & GUTTER

LEGEND -O- New Trench -®- New Bore Existing Gas - Existing Water Existing Telephone Existing Sewar Existing Storm Drain Existing Electric Existing Manhole Eldeting Handhole (2'x3' or 17"x30") DSLAW 250 X-CONNECT POWER PEDESTAL TELCO PEDESTAL 3' X 5' PULL BOX Ø POLE


COMMUNICATIONS

JOB ID: 5291557 TITLE: FOH - 1619 E LAKE DR STREET ADDRESS: 1619 E LAKE DR CITY/STATE: GLADEWATER, TX 75647 (UPSHUR COUNTY)

FTR ENGINEER: CORY RIGGS (310) 210-9882 FTR INSPECTOR: JAMES WEST (972) 578-3224

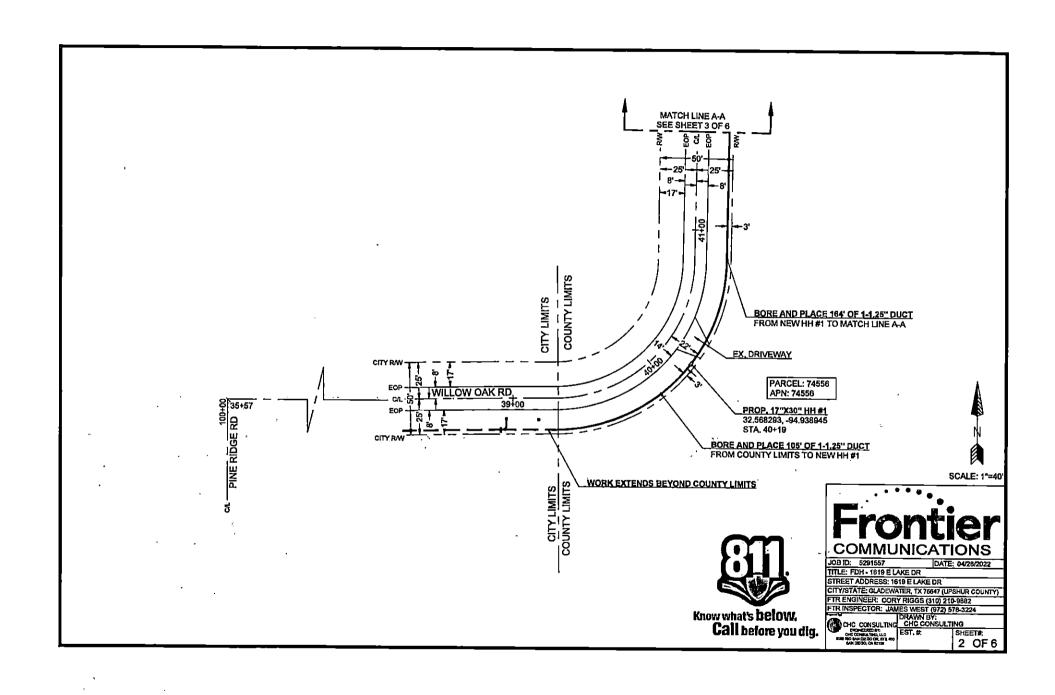

	CURVE	RADIUS	LENGTH	DELTA
	C1	6'	LENGTH 9'	90"
				2 1
			80	ALE: 1"=40'
		OF MUNIO	CATIC	ONS W28/2022
Ī	OB ID: 6291 TTLE: FDH - 16	319 E LAKE DE	₹	

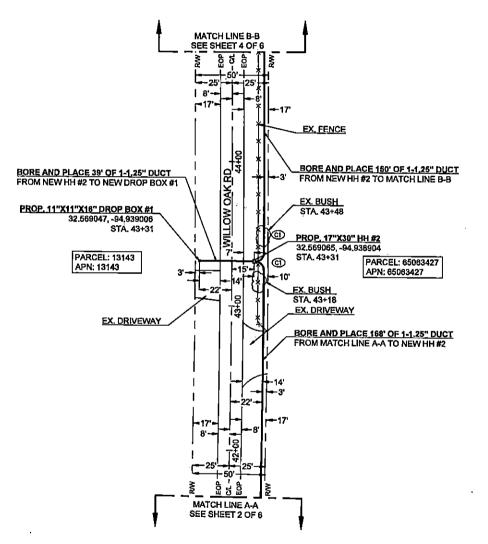




Know what's below. Call before you dig.

TITLE: FDH - 1619 E LAKE DR STREET ADDRESS: 1619 E LAKE DR


CITY/STATE: GLADEWATER, TX 75647 (UPSHUR COUNTY) FTR ENGINEER: CORY RIGGS (310) 210-9882
FTR INSPECTOR: JAMES WEST (972) 578-9224

OCHC CONSULTING
DESCRIPTION
OF CONSULTIN

SHEET#: 3 OF 6

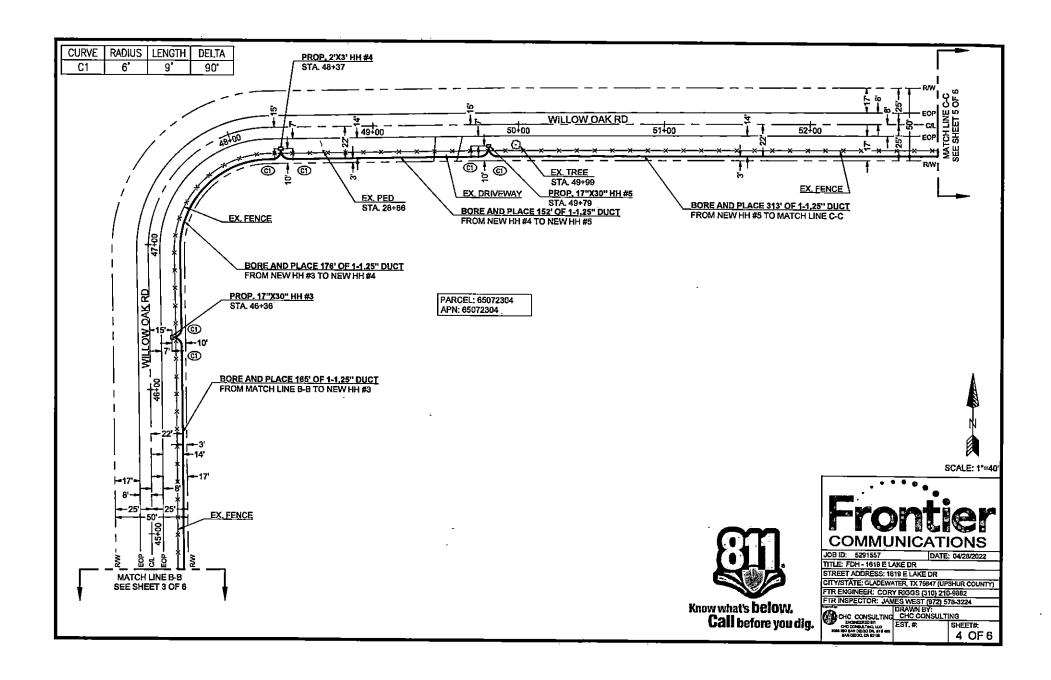

CURVE	RADIUS	LENGTH	DELTA
C1	6'	9'	90,

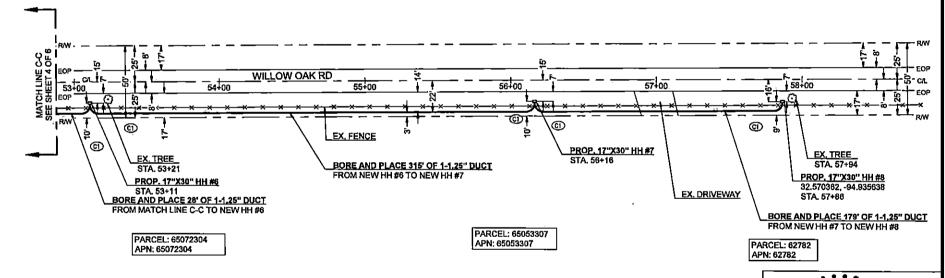









JOB ID: 5291557 TITLE: FDH - 1819 E LAKE DR STREET ADDRESS: 1619 E LAKE DR STREET ADDRESS: 1619 E LAKE DR
CITY/STATE: GLADEWATER, TX 75647 (UPSHUR COUNTY)
FIR ENGINEER: CORY RIGGS (310) 210-9882
FIR INSPECTOR: JAMES WEST (972) 578-3224
DRAWN BY:
CHC CONSULTING
PROFESSOR OF STREET OF STREET

MINIMUM STANDARDS FOR DIRECTIONAL BORING

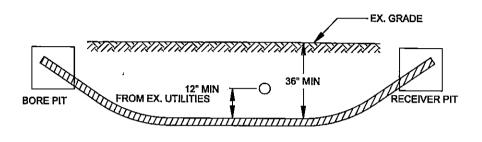

- PLACE END MARKER WITH UTILITY OWNER'S NAME DESCRIBING CONDUIT BORE PIT TO BE BACKFILLED AND COMPACTED IN 12" LIFTS WITH MATERIAL REMOVED
- -FLOW OF DITCH MUST BE MAINTAINED AT ALL TIMES
- PROTECT ROOTS AT ALL TREE LOCATIONS, SHIFT BORE TRENCH IF NECESSARY

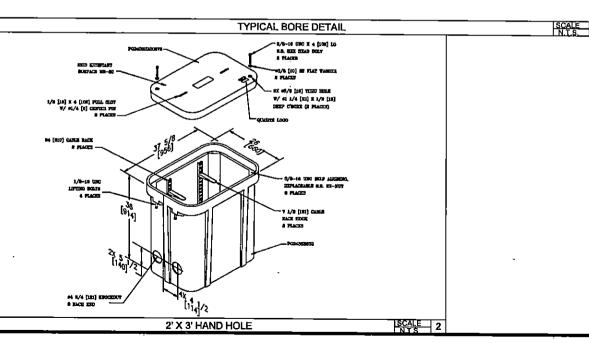



JOB ID: 5291557 DATE: 04/28/2022

TITLE: FDH - 1819 E LAKE DR

STREET ADDRESS: 1619 E LAKE DR

CITY/STATE: GLADEWATER, TX 75647 (UPSHUR COUNTY)

FTR ENGINEER: CORY RIGGS (310) 210-9882

TIR INSPECTOR: JAMES WEST (972) 578-3224

TIR INSPECTOR: JAMES WEST (972) 578-3224

DRAWN BY:
CHC CONSULTING
CHC CONSULTING
CHC CONSULTING
STREET

SHEETS

6 O SHEET#, 6 OF 6

FRONTIER COMMUNICATION CONSTRUCTION SPECIFICATIONS

- Contact Frontier Engineer CORY RIGGS (310) 210-9882 sixty (60) days prior to need of service in order to confirm compliance,order materials, and schedule work forces, NOTE; FRONTIER COMMUNICATIONS, INCORPORATED, RESERVES THE RIGHT TO REFUSE ANY CONDUIT, PULL BOXES, MANHOLES, OR UTILITY BOXES THAT DEVIATE FROM PLANS AND SPECIFICATIONS.
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- All horizontal ninety (90) degree bends shall have a minimum radius of 12.5 feet and all vertical ninety (90) degree bends shall have a minimum radius of three feet. No more than two ninety (90) degree horizontal bends shall be placed in any single run unless otherwise specified. Contact the Frontier engineer concerning any required deviations.
- All conduit must be proven using a mandrel no less than a 1/2" smaller than the conduit placed. Wall to wall measurements must be taken with a measured tape and a 3/8" polypropylene pull rope in each duct. An accurate wall to wall measurement of conduit placed must be As-built on an approved Frontier construction plan. A copy of the As-built conduit work order must be provided to the Frontier inspector assigned to your project.
- Place weatherproof caps on all terminated conduits.
- Approved plastic conduit (PVC Sch. 40,TYPE-C or HDPE (2") is to be used in underground construction unless otherwise specified.
- Conduit terminated on a pole must be PVC Sch. 80, Location of riser on pole will be called out by engineering on the construction plan.
- Conduit placed in same tranch with primary power conduit must be separated by a minimum of twelve (12) inches of well-packed sand or three inches of concrete, and have a minimum of thirty-six (38) inches of cover when placed behind curb face, All street crossings and conduits placed in the driven portion of the roadway must have a minimum of forty-eight (48) linches of cover to top of pipe. CONTACT THE FRONTIER INSPECTOR 48. HOURS BEFORE TRENCHING AND UPON COMPLETION OF YOUR SUBSTRUCTURES TO SCHEDULE THE FINAL INSPECTION.

PERMITTING AGENCY: CITY OF GLADEWATER

PICK UP POINT: EX. POLES

PATH FOOTAGE:




MATERIALS: (1) NEW PAD MOUNT FDH 288 (1) NEW 20"X40"X6" CONCRETE PAD (1) NEW 3'X3' HH (19) NEW 11"X11"X18" DROP BOX (24) NEW 17"X30" HH 20) NEW 23(3) HH

12580' OF (1)-1,25" DUCT 238' OF (2)-1,25" DUCTS 12' OF (3)-1.25" DUCTS 5' OF (1)-4" DUCT

CONSTRUCTION PACKAGE

FDH- 1619 E LAKE DR E LAKE DR & CANNON ST **GLADEWATER, TX 75647**

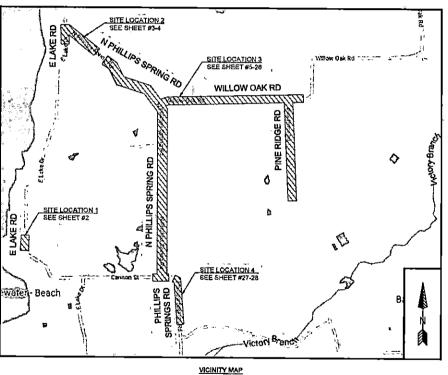

-HDPE AND PVC FOOTAGES DO NOT INCLUDE SWEEPS -ACTUAL FOOTAGES OF HDPE AND PVC WILL BE NEEDED TO ORDER MATERIALS, PLEASE INCLUDE MEASURED TAPE IN ALL PVCS. -FRONTIER INSPECTOR SHALL BE PRESENT ON SITE WHEN CONTRACTOR NEEDS TO ACCESS ANY EXISTING FRONTIER FACILITY.

ADDDEVANTIONS


	<u>ARRKENIA</u>	HONS		
BLDG	BUILDING	PED	PEDESTAL (UTILITY)	
C/L	CENTER LINE	PVC	POLYVINYL CHLORIDE	
CONC	CONCRETE	P/L	PROPERTY LINE	
CSW	CONCRETE SIDEWALK	RR	RAILROAD	
DWY	DRIVEWAY	R/W	RIGHT OF WAY	
EOC	EDGE OF CURB	St.	STREET LIGHT	
EOP	EDGE OF PAVEMENT	W-BLDG	WALL TO BUILDING	
ETW	ETW LINE	WP	WALL TO POLE	
HH	HANDHOLE	W-W	WALL TO WALL	
MH	MANHOLE	P.U.E.	PUBLIC UTILITY EASEMENT	т
NTS	NOT TO SCALE	P.S.E.	PUBLIC SERVICE EASEME	N
		C/G	CURB & GUTTER	


LEGEND - New Trench -@- New Bore Eulatino Gos Eduling Water Existing Telephone Existing Sever Existing Storm Oraln Existing Electric Existing Manhole Existing Handhole (2'x3' or 17"x30") E DSIAN DEC X-CONNECT POWER PEDESTAL TELCO PEDESTAL 3' X 6' PULL BOX POLE





JOB ID: 5291557 TITLE: FDH - 1819 E LAKE DR STREET ADDRESS: 1619 E LAKE DR CITY/STATE: GLADEWATER, TX 75647 (UPSHUR COUNTY) FTR ENGINEER: CORY RIGGS (310) 210-9882 FTR INSPECTOR: JAMES WEST (972) 578-3224


CHC CONSULTING
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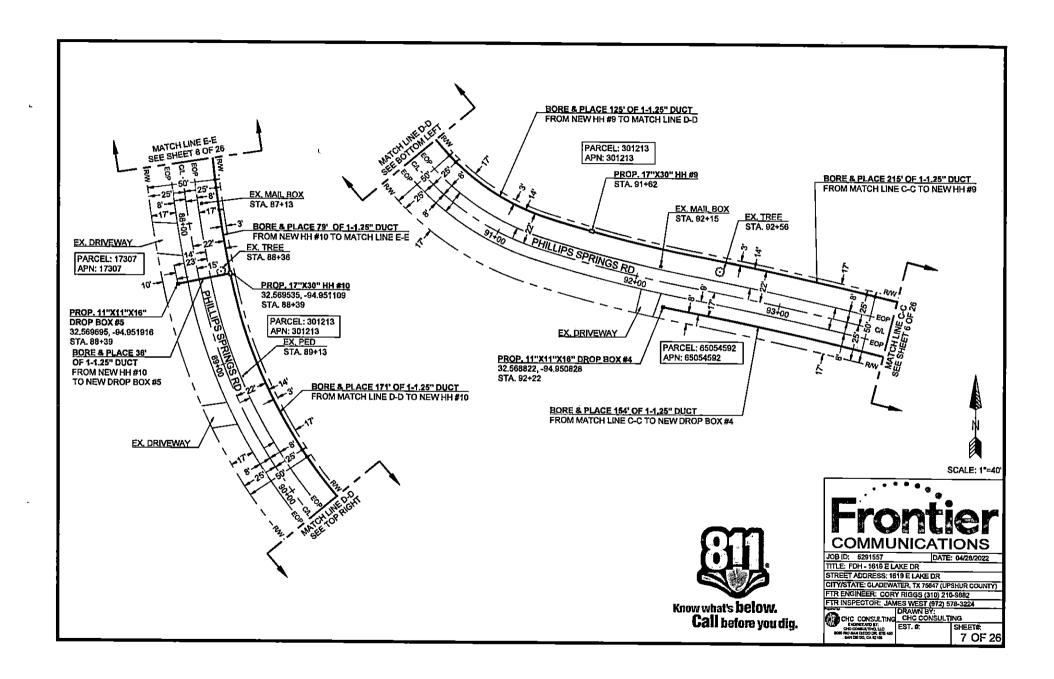


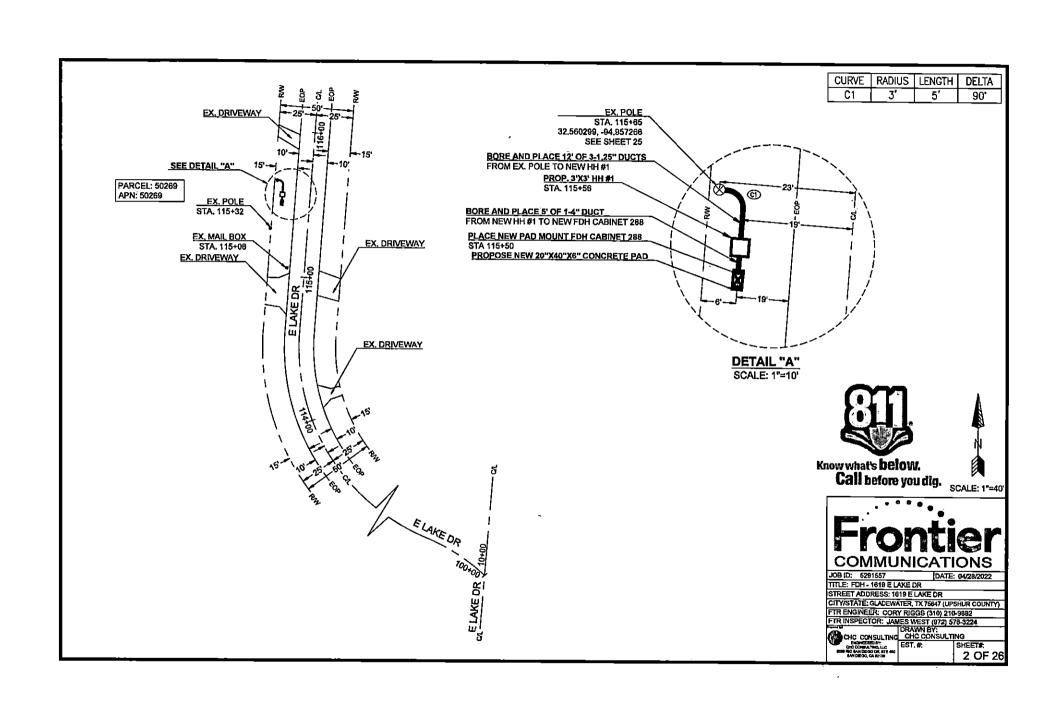


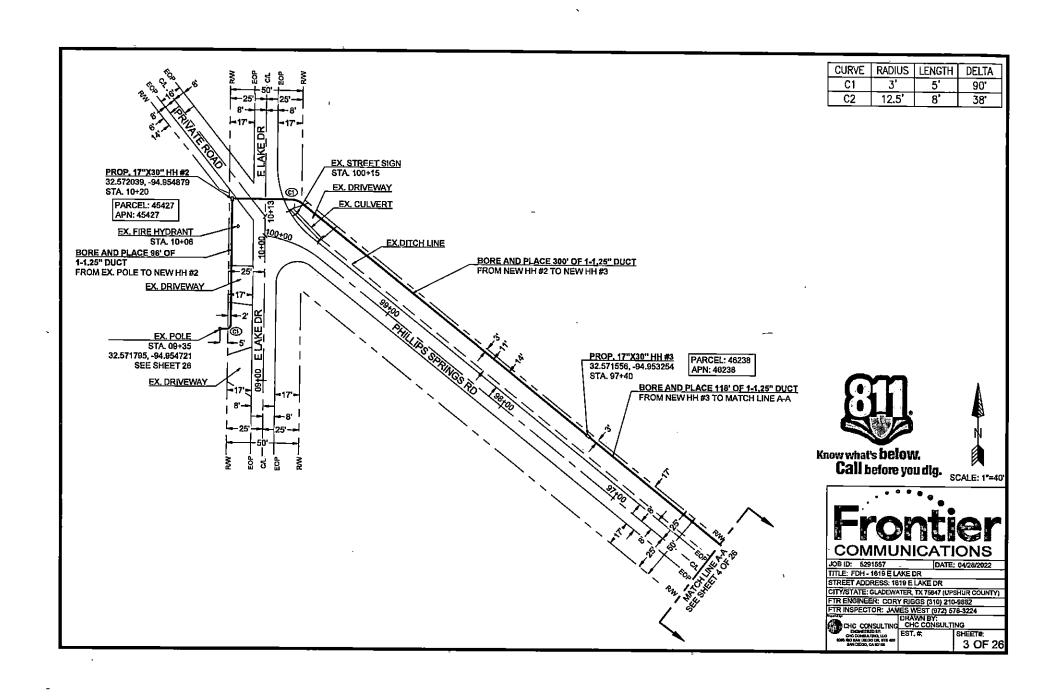

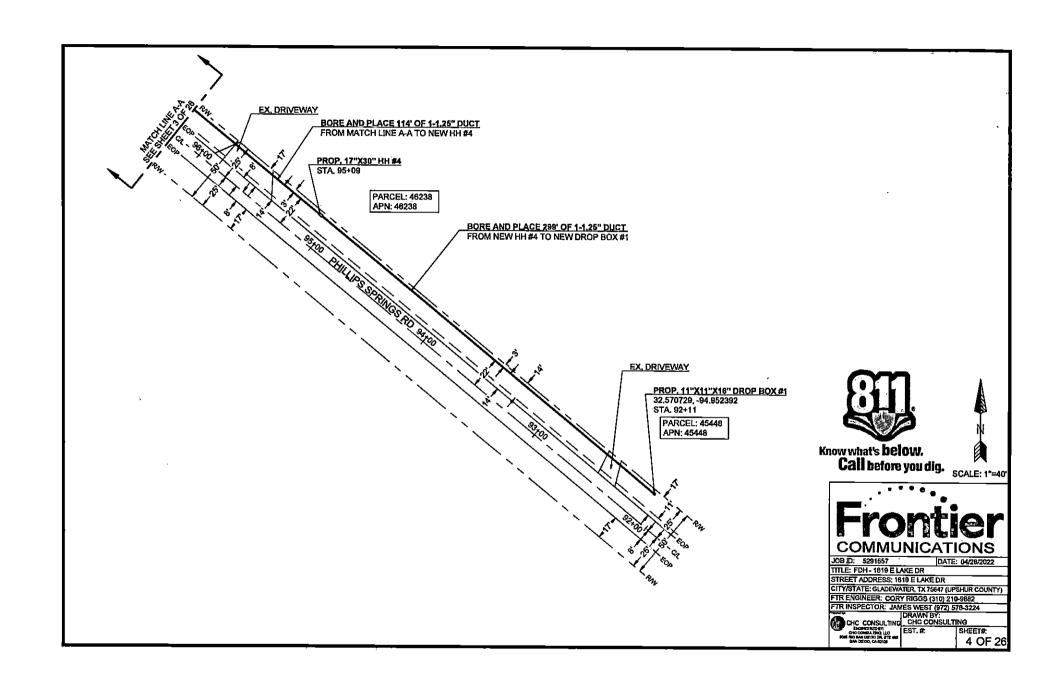

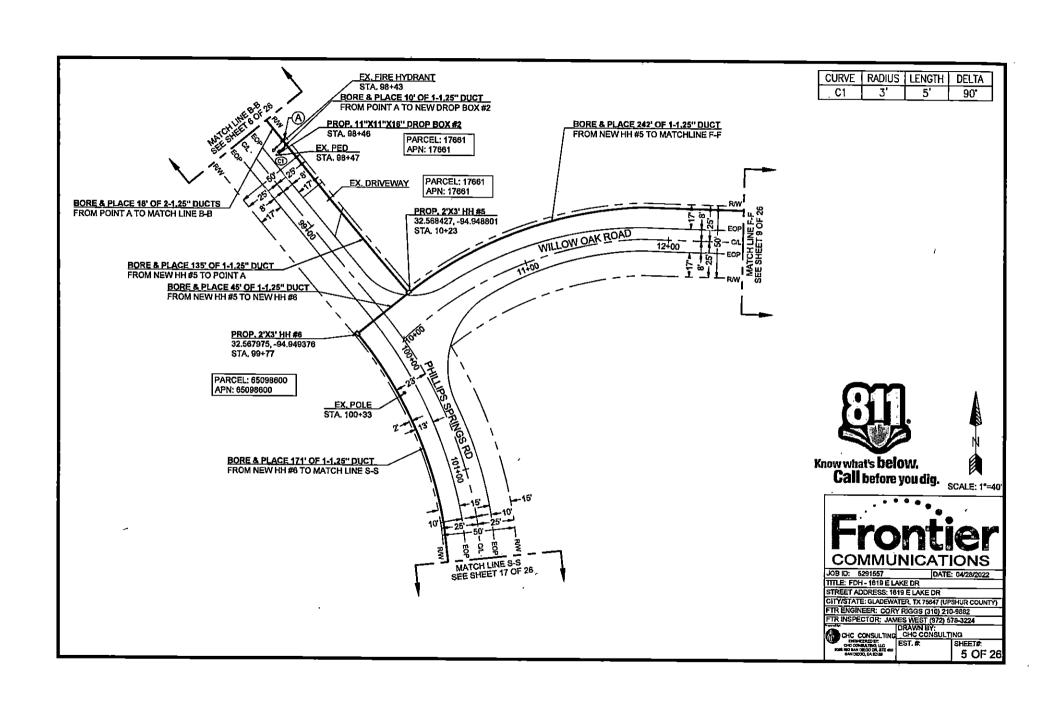

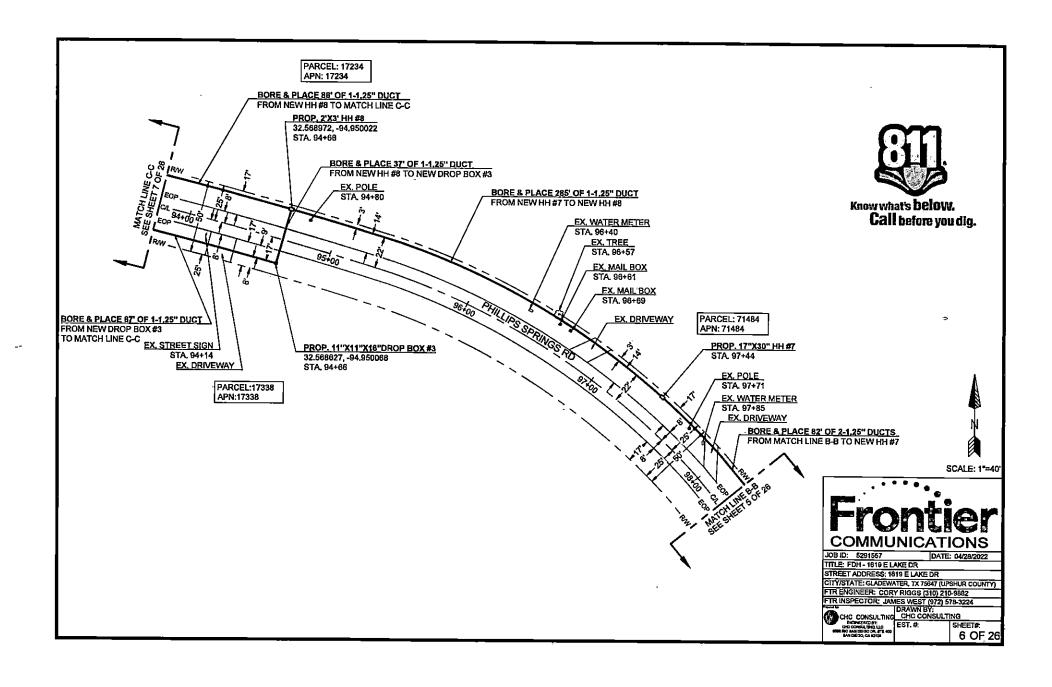

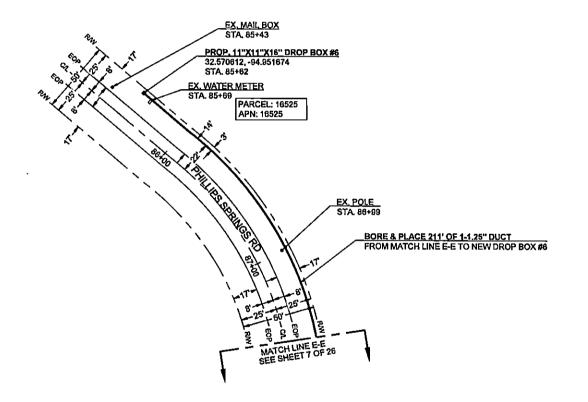






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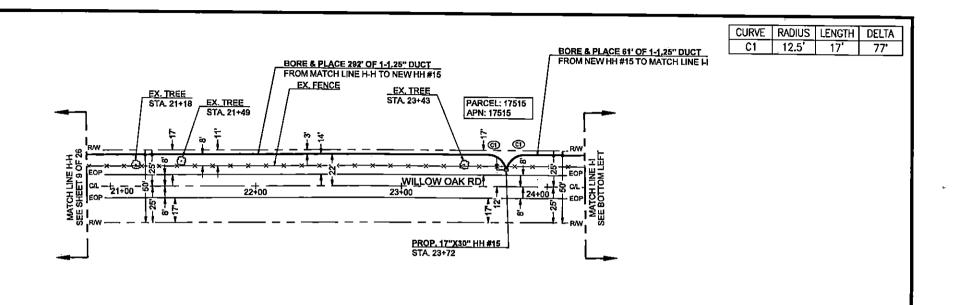



JOB ID: 5291557 DATE: 04/28/2022

JOB ID: 5291557 DATE: 04/28/2022
TITLE: FDH - 1819 E LAKE DR
STREET ADDRESS: 1619 E LAKE DR
CITY/STATE: GLADEWATER, TX 75947 (UPSHUR COUNTY)
FTR ENGINEER: CORY RIGGS (310) 210-9882
FTR INSPECTOR: JAMES WEST (972) 576-3224
DRAWN BY:
CHC CONSULTING
ENGRAPMENT OF THE CHC CONSULTING
ESTATE OF THE

SHEET#: 8 OF 26



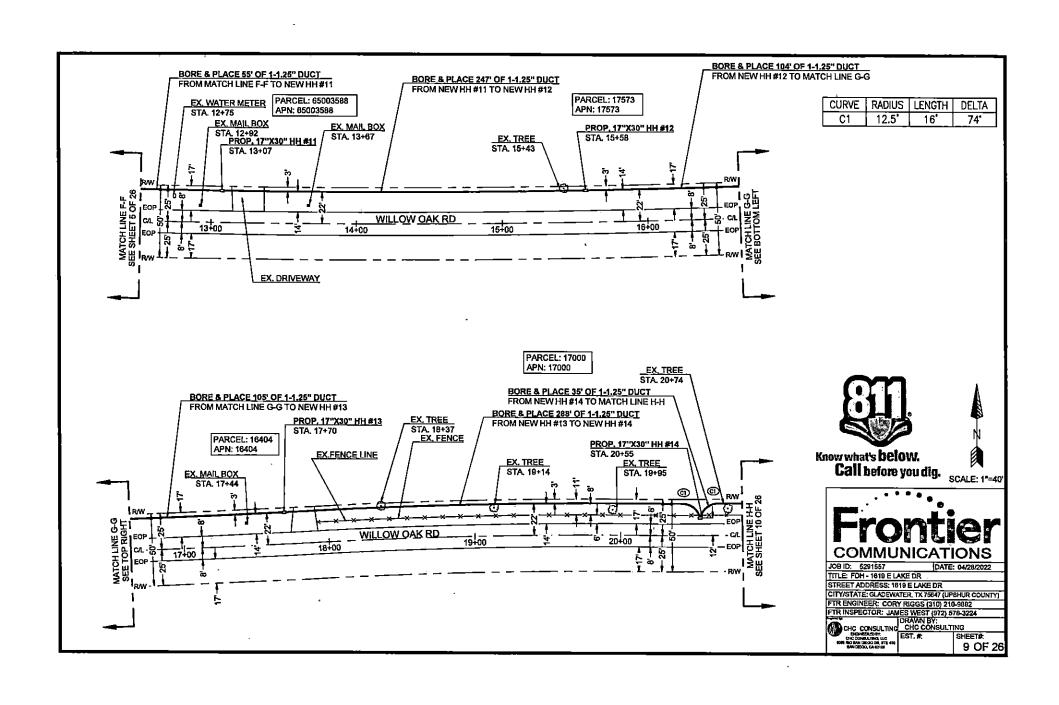

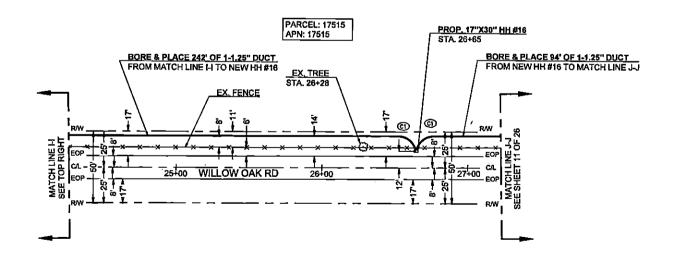








JOB ID: 5291557 DATE: 04/26/2022 TITLE: FDH - 1619 E LAKE DR

TITLE: FOH - 1819 E LAKE DR
STREET ADDRESS: 1819 E LAKE DR
CITY/STATE: GLADEWATER, TX 76847 (UPSHUR COUNTY)
FIR ENGINEER: CORY RIGGS (310) 210-9882
FIR INSPECTOR: JAMES WEST (972) 578-3224
DRAWN BY:
CONSULTING
CHC CO

		_	
CURVE	RADIUS	LENGTH	DELTA
C1	12.5	17'	76'
C2	12.5'	16	74'
C3	12.5	17'	78'

PARCEL: 17312 APN: 17312

PARCEL: 17515 APN: 17515

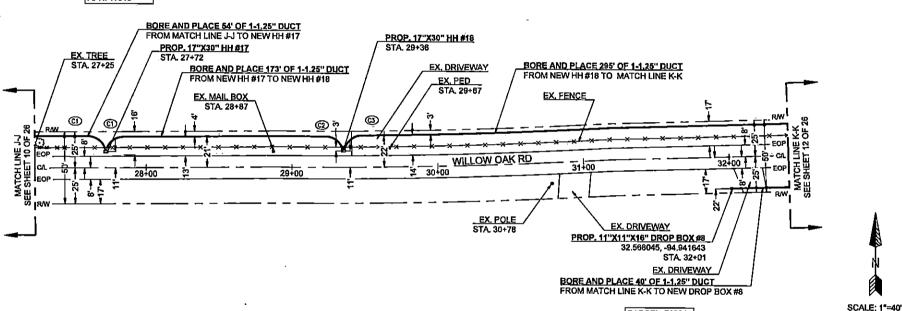

PARCEL: 76864 APN: 76864



Know what's below.

Call before you dig.



JOB ID: 5291657 DATE: 04/28/2022 TITLE: FDH - 1619 E LAKE DR


STREET ADDRESS: 1619 E LAKE DR

CITY/STATE: GLADEWATER, TX 75647 (UPSHUR COUNTY)

FTR ENGINEER: CORY RIGGS (310) 210-9882
FTR INSPECTOR: JAMES WEST (972) 578-3224


OCC CONSULTING
DESCRIPTION
DESCRIPTION
ENGINEER CONSULTING
ENGIN


SHEET#: 110F 26

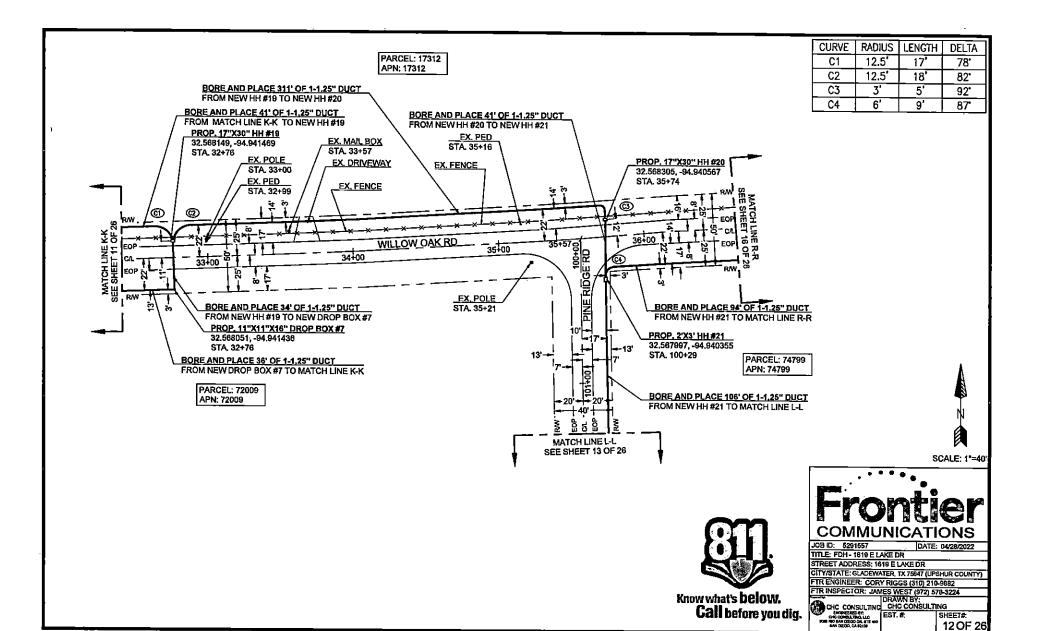



Call before you dig.


SHEET#: 12 OF 26

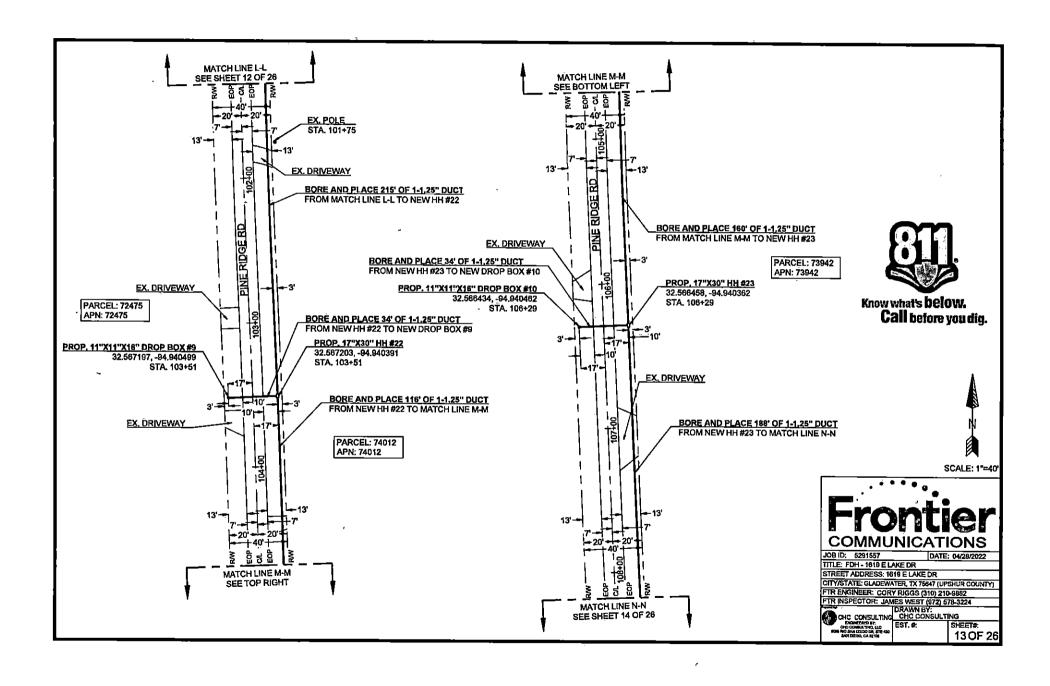

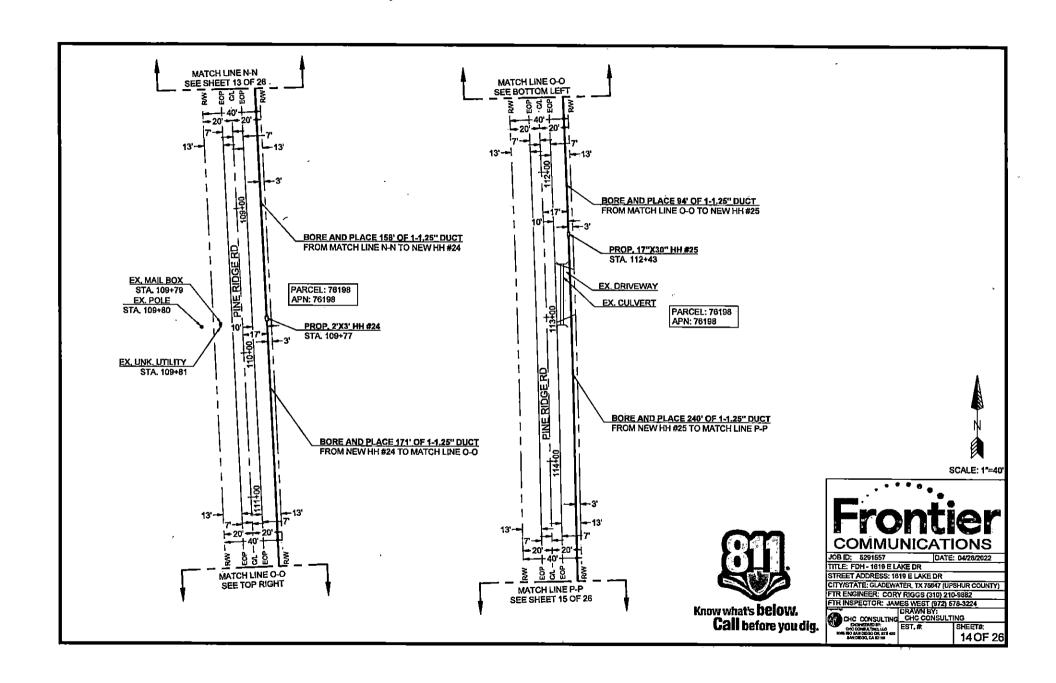

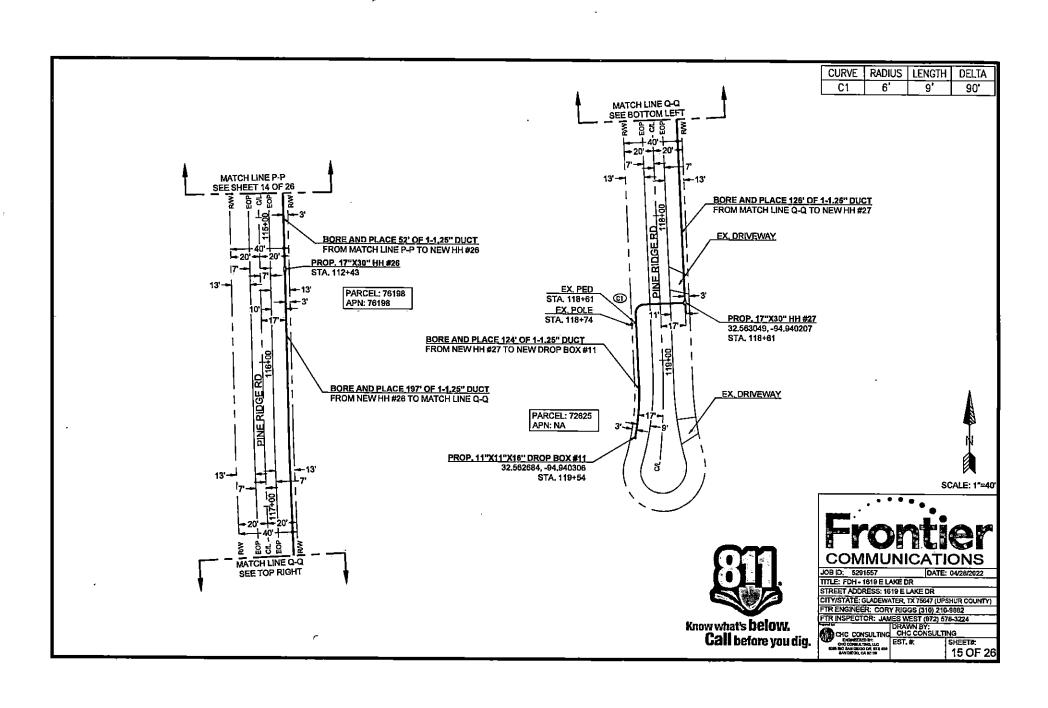

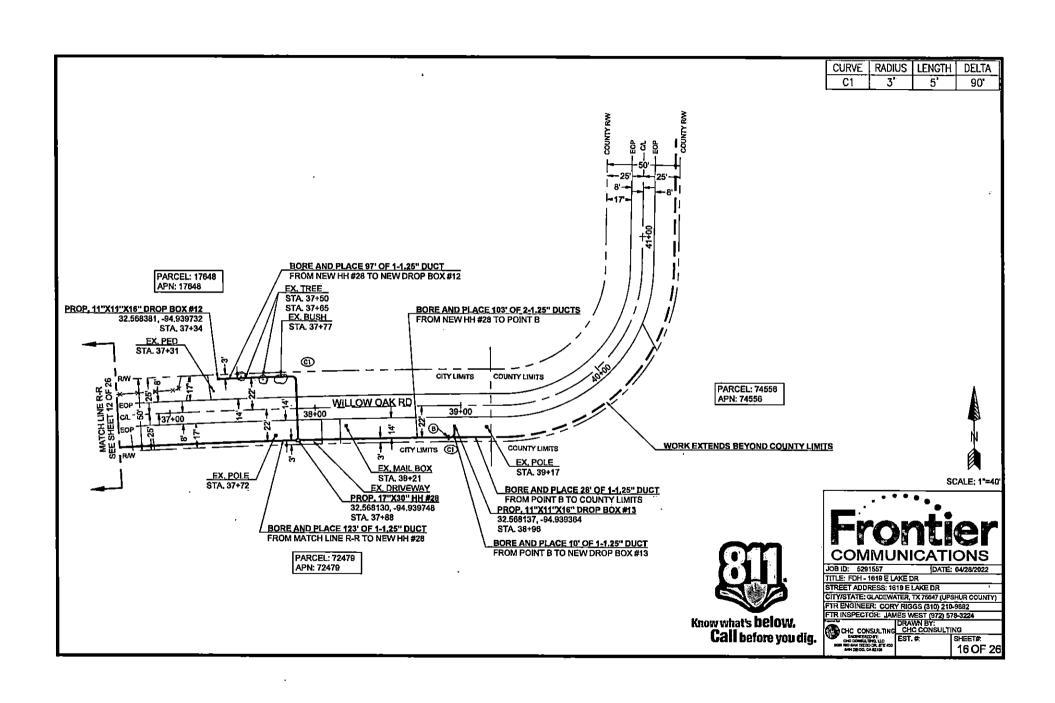

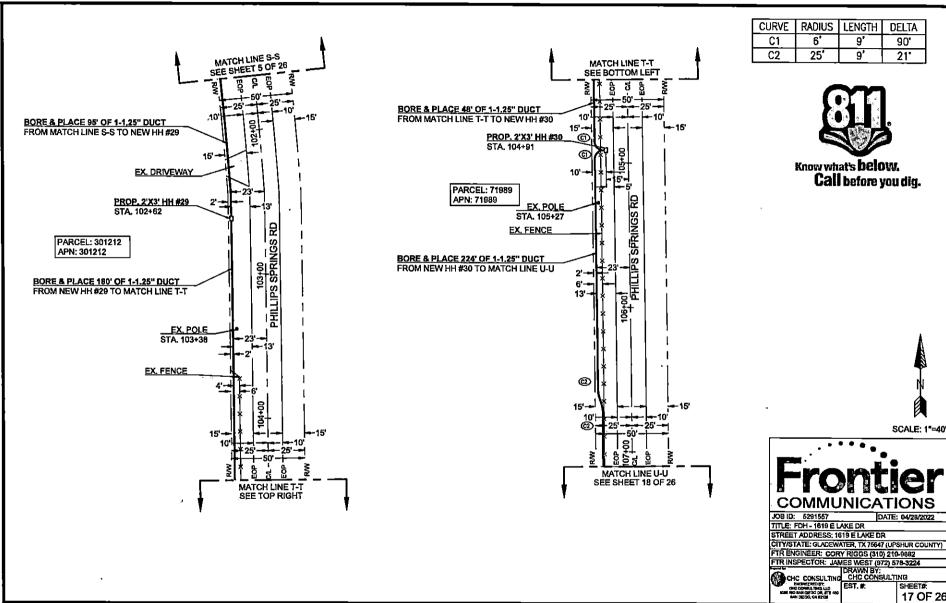

CURVE	RADIUS	LENGTH	DELTA
C1	6'	9'	90'
C2	25'	9'	21°








COMMUNICATIONS


DATE: 04/28/2022


SHEET#: 17 OF 26

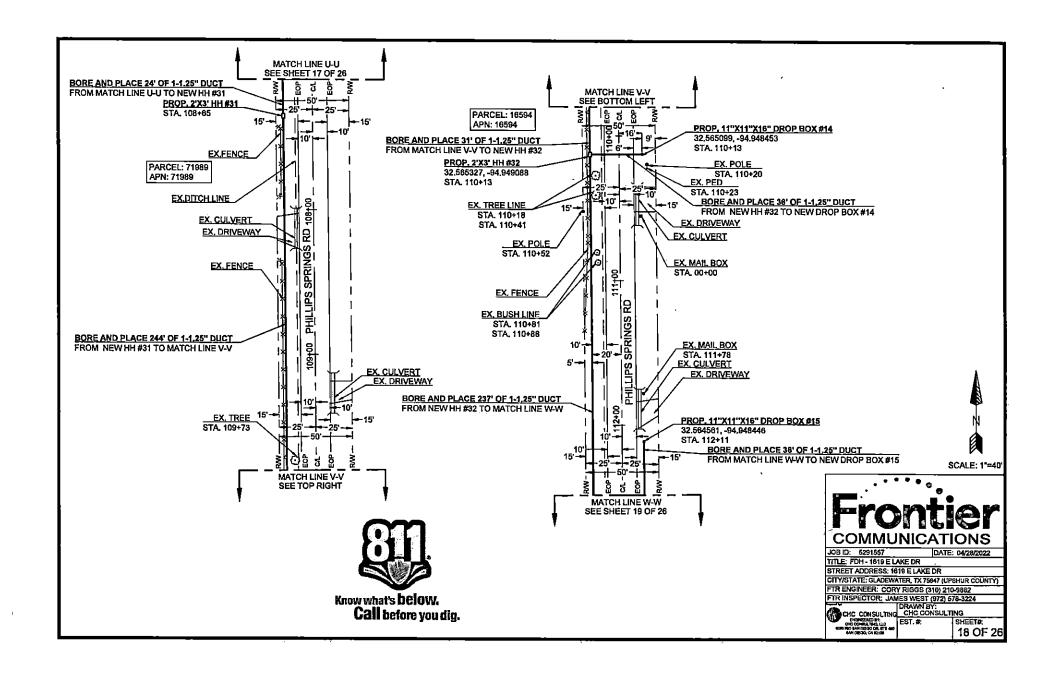


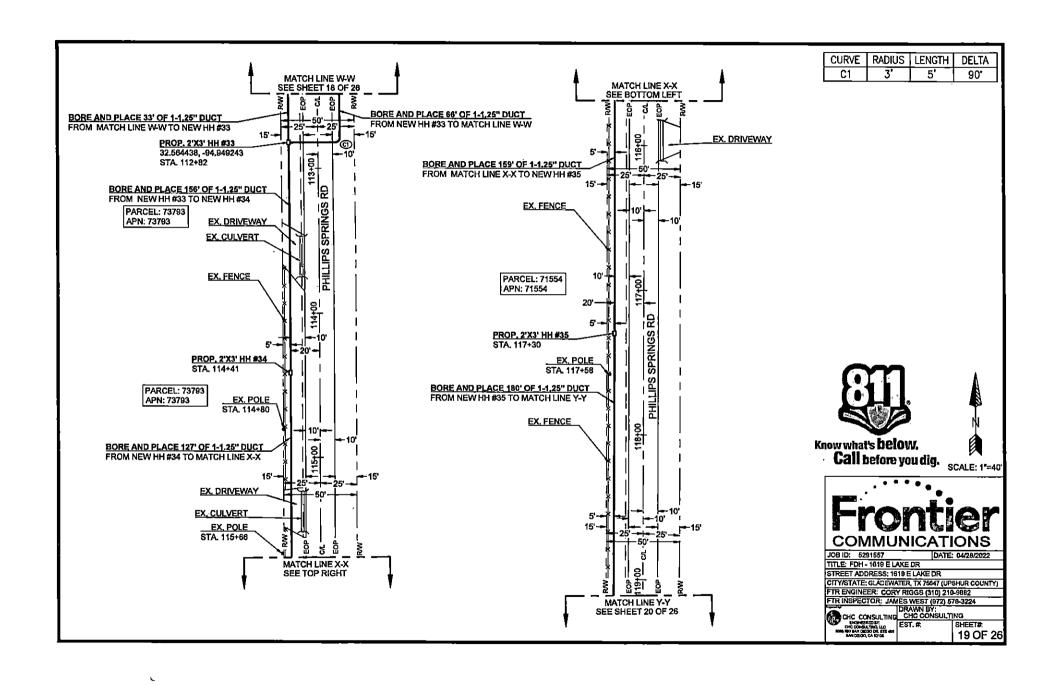

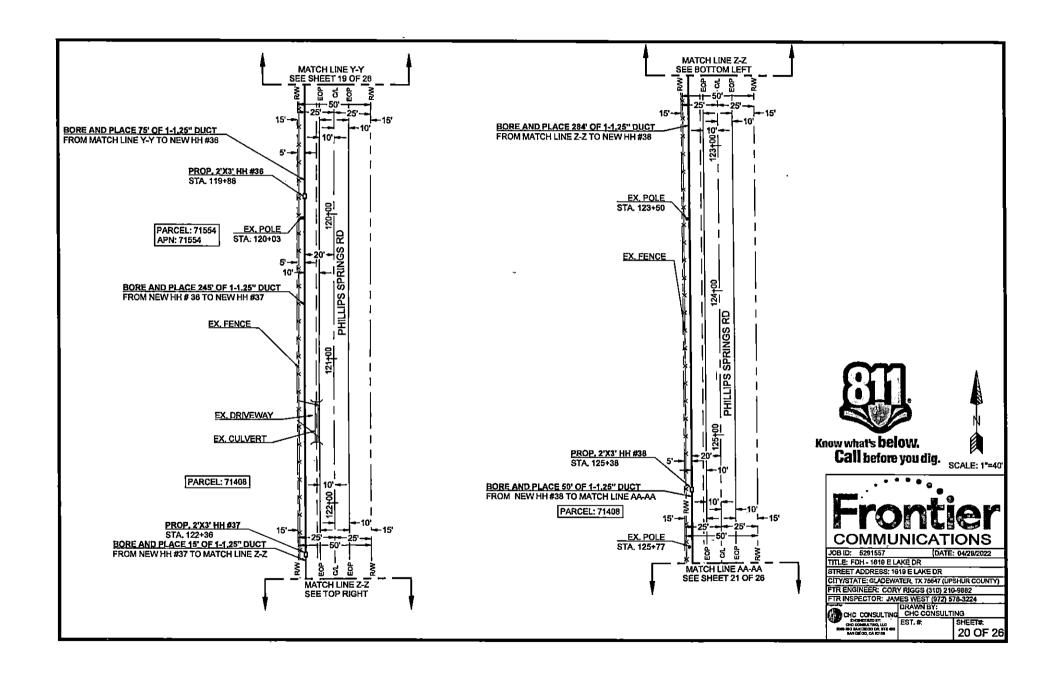

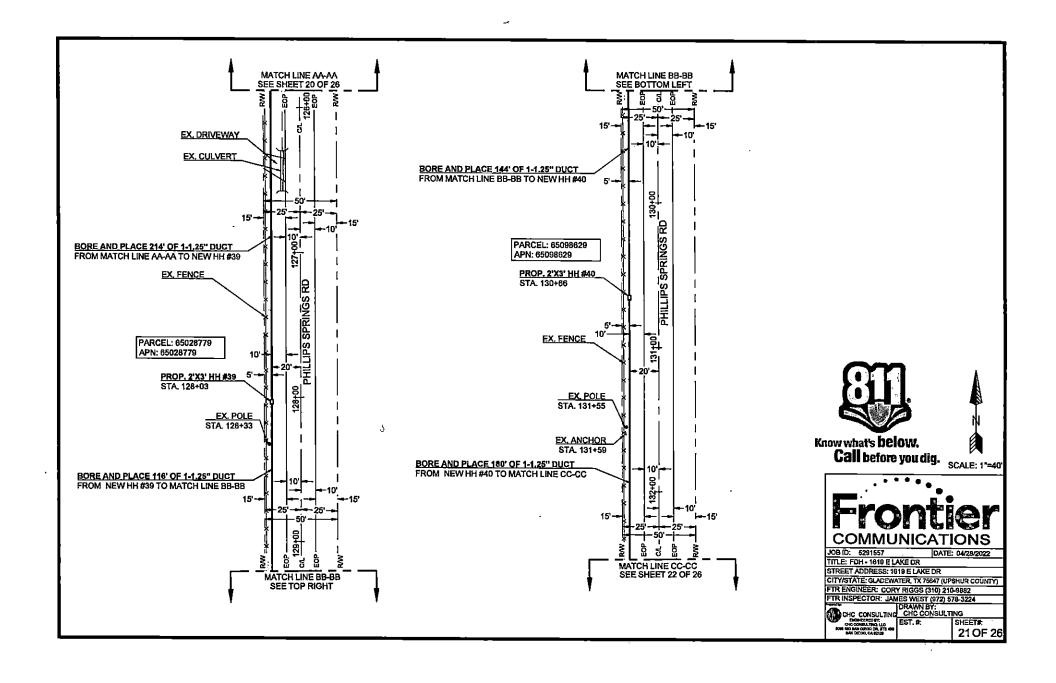

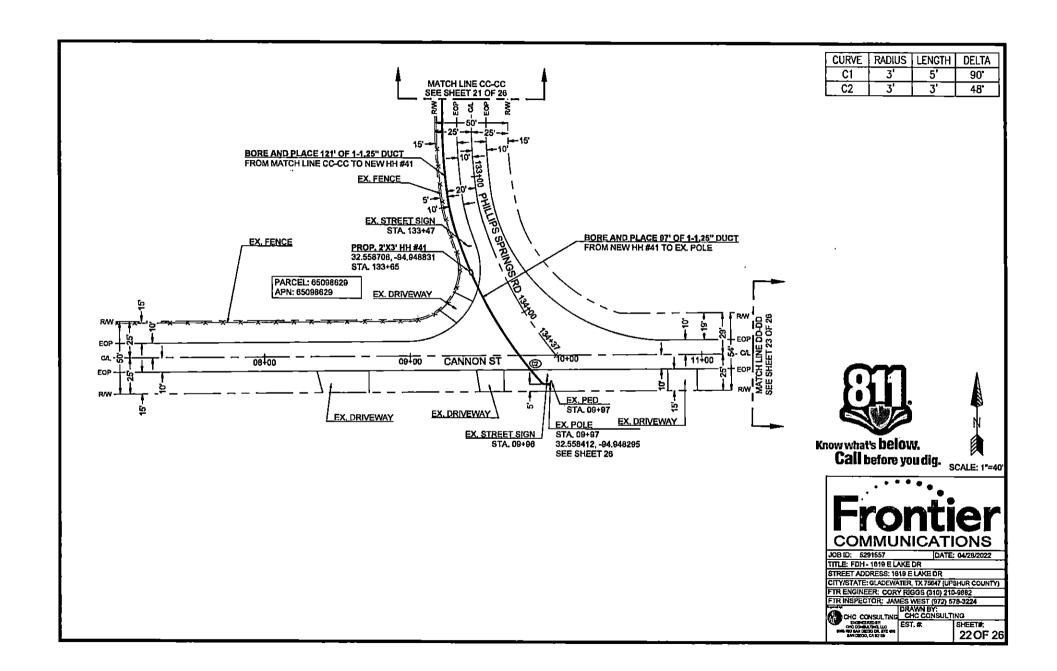

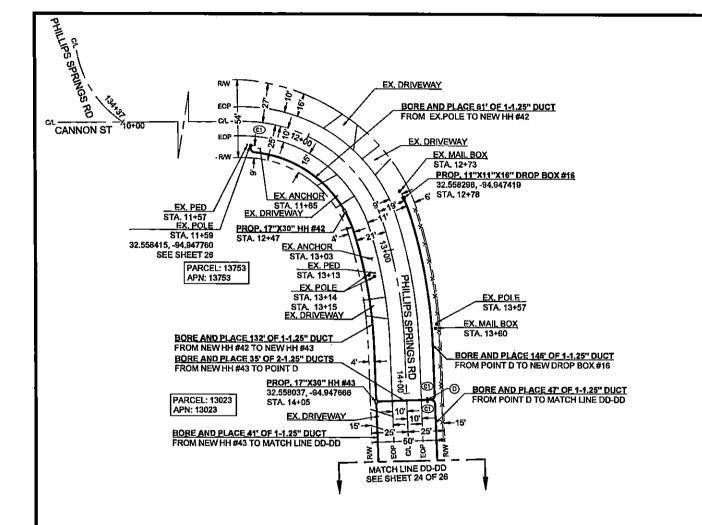

CURVE RADIUS LENGTH DELTA 3' 90,







JOB ID: 5291557 DATE: 04/28/2022

TITLE: FDH - 1619 E LAKE DR

STREET ADDRESS: 1619 E LAKE DR


CITY/STATE: GLADEWATER, TX 75847 (UPSHUR COUNTY)


FTR ENGINEER: CORY RIGGS (310) 210-9882


FIR INSPECTOR: JAMES WEST 1972 678-3224
FIR INSPECTOR: JAMES WEST 1972 678-3224
DRAWN BY:
CHC CONSULTING
CHC CONSULTING
CHC CONSULTING
EST. #: SHEETI

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23 OF 26



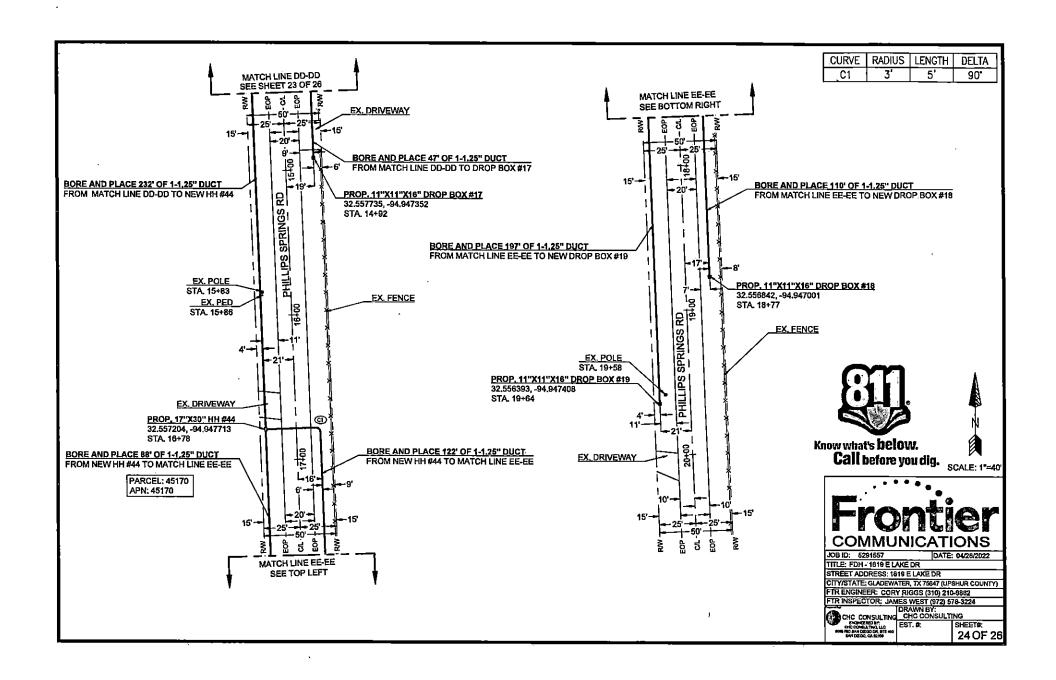

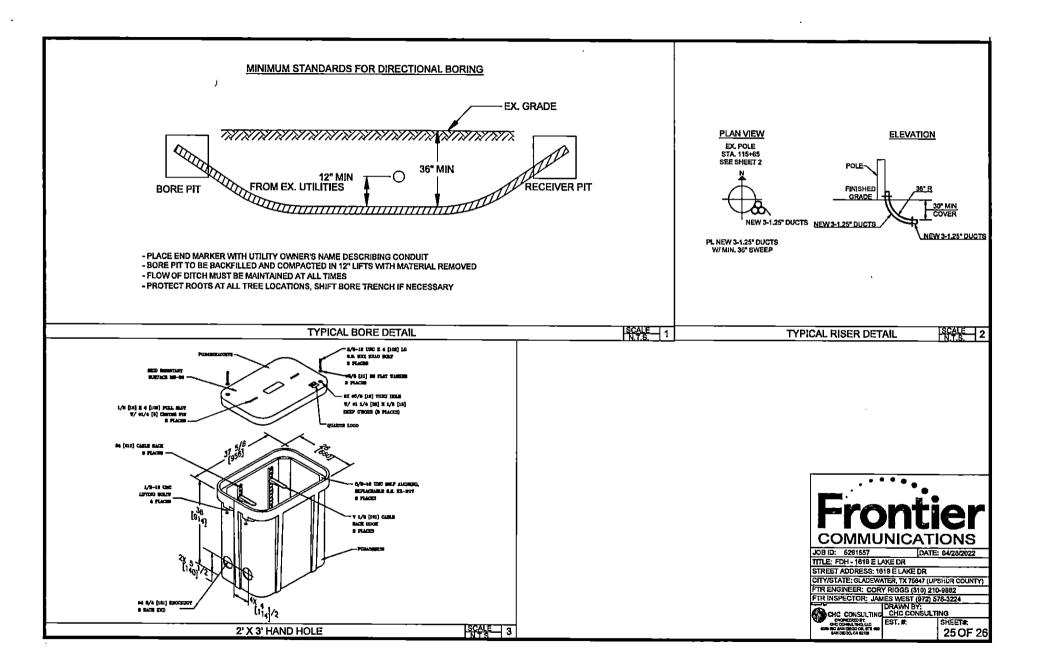


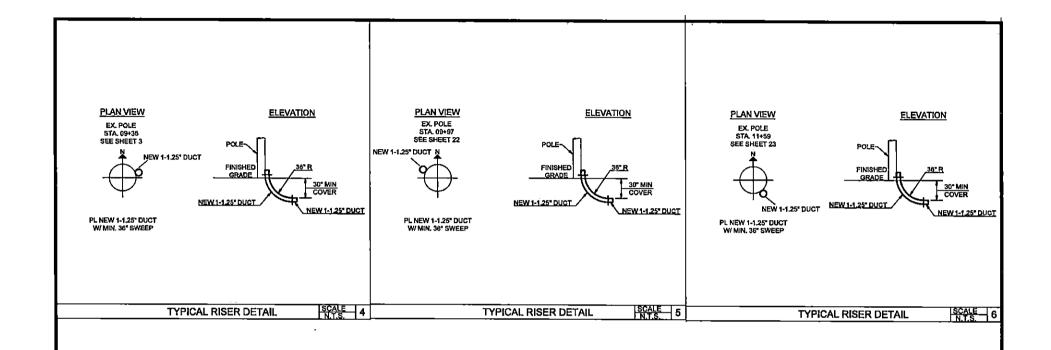

Frontier

TRAFFIC CONTROL PLAN JOB 5291557

BORING, AERIAL PL., CONCRETE PAD, FDH CABINET PL., HH & DB ACCESS 1832 PHILLIPS SPRINGS RD. GLADEWATER, TX.

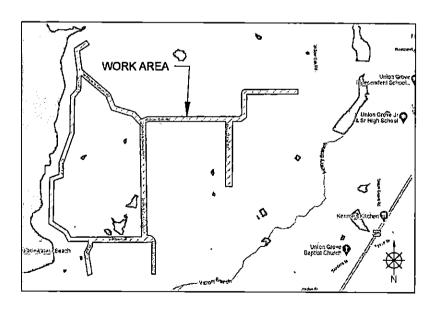

TRAFFIC CONTROL PLAN GENERAL NOTES

- 1. FLAGS ATTACHED TO SIGNS WHERE SHOWN ARE OPTIONAL.
- ALL TRAFFIC CONTROL DEVICES ILLUSTRATED ARE REQUIRED, EXCEPT THOSE DENOTED WITH THE TRIANGLE SYMBOL ARE
 OPTIONAL.
- INACTIVE WORK VEHICLES OR OTHER EQUIPMENT SHOULD BE PARKED NEAR THE RIGHT-OF-WAY LINE AND NOT PARKED ON THE PAVED SHOULDER.
- 4. A SHADOWVEHICLE WITH A TMA SHOULD BE USED ANYTIME IT CAN BE POSITIONED 30 TO 100 FEET IN ADVANCE OF THE AREA OF CREW EXPOSURE WITHOUT ADVERSELY AFFECTING THE PERFORMANCE OR QUALITY OF THE WORK. IF WORKERS ARE NO LONGER PRESENT BUT ROAD OR WORK CONDITIONS REQUIRE THE TRAFFIC CONTROL TO REMAIN IN PLACE, TYPE 3 BARRICADES OR OTHER CHANNELIZING DEVICES MAY BE SUBSTITUTED FOR THE SHADOW VEHICLE AND TMA.
- 5. ADDITIONAL SHADOW VEHICLES WITH TMAS MAY BE POSITIONED OFF THE PAVED SURFACE, NEXT TO THOSE SHOWN IN ORDER TO PROTECT WIDER WORK SPACES.
- 6. CONTRACTOR SHALL PROVIDE AND INSTALL TRAFFIC CONTROL DEVICES IN CONFORMANCE WITH PART VI OF TEXAS MANUAL ON UNIFORM TRAFFIC CONTROL DEVICES (TMUTCD LATEST EDITION WITH REVISIONS) DURING CONSTRUCTION.
- 7. CONTRACTOR TO CONTACT CITY OF PORT ARTHUR AT LEAST 48 HOURS PRIOR TO CONSTRUCTION.
- RIGHT OF WAY WILL BE RESTORED TO EQUAL OR BETTER CONDITION WHEN PITS SHALL BE KEPT AT LEAST 3' FROM THE ROAD.

CONSTRUCTION IS COMPLETED, BORE

- NO TRAFFIC LANES WILL BE CLOSED DURING CONSTRUCTION. THERE WILL BE NO LANE CLOSURES IN THIS PROJECT,
- CONSTRUCTION WILL LAST 1-2 DAYS.

Product Speed	Formula	Marinus Desirable Tapur Langtus "L"		Buggested Maximum Specing of Charactering Devices		Marking Specing 200	Suggested Longitudinal Buffer Space	
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* Conventional Reads Only

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-	Pgs	♦	Yorks Flow			
a	neg .	Ş	Proper			

DESCRIED BY:
PRACHAST THACUP

DRAWN BY:
PRACHAST THACUR

PRACHAST THACUR

PROTECTS

ECHC

A CONGRUEX COMPANY 9095 Río San Diego Dr. Ste 165 San Diego, CA 92108-1694 (949)250-0004 /FAX (949)250-0006

